220 PARK ROAD BURLINGAME, CA



PLANNING RESUBMITTAL 06.22.2020

PROJECT TEAM:

APPLICANT

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CIVIL ENGINEER

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JASON MANSFIELD: jmansfield@bkf.com

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ISSUES AND REVISIONS

03.30.2020 PLANNING SUBMITTAL (A) 06.22.2020 PLANNING RESUBMITTAL #1

COLOR RENDERING VIEW FROM PARK ROAD







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ISSUES AND REVISIONS

03.30.2020 PLANNING SUBMITTAL

06.22.2020 PLANNING RESUBMITTAL #1

PROJECT NUME

SHEET TITLE

COLOR RENDERING VIEW FROM LORTON AVENUE

N







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PROJECT NUMB


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COLOR RENDERING VIEW FROM LORTON AVENUE

14





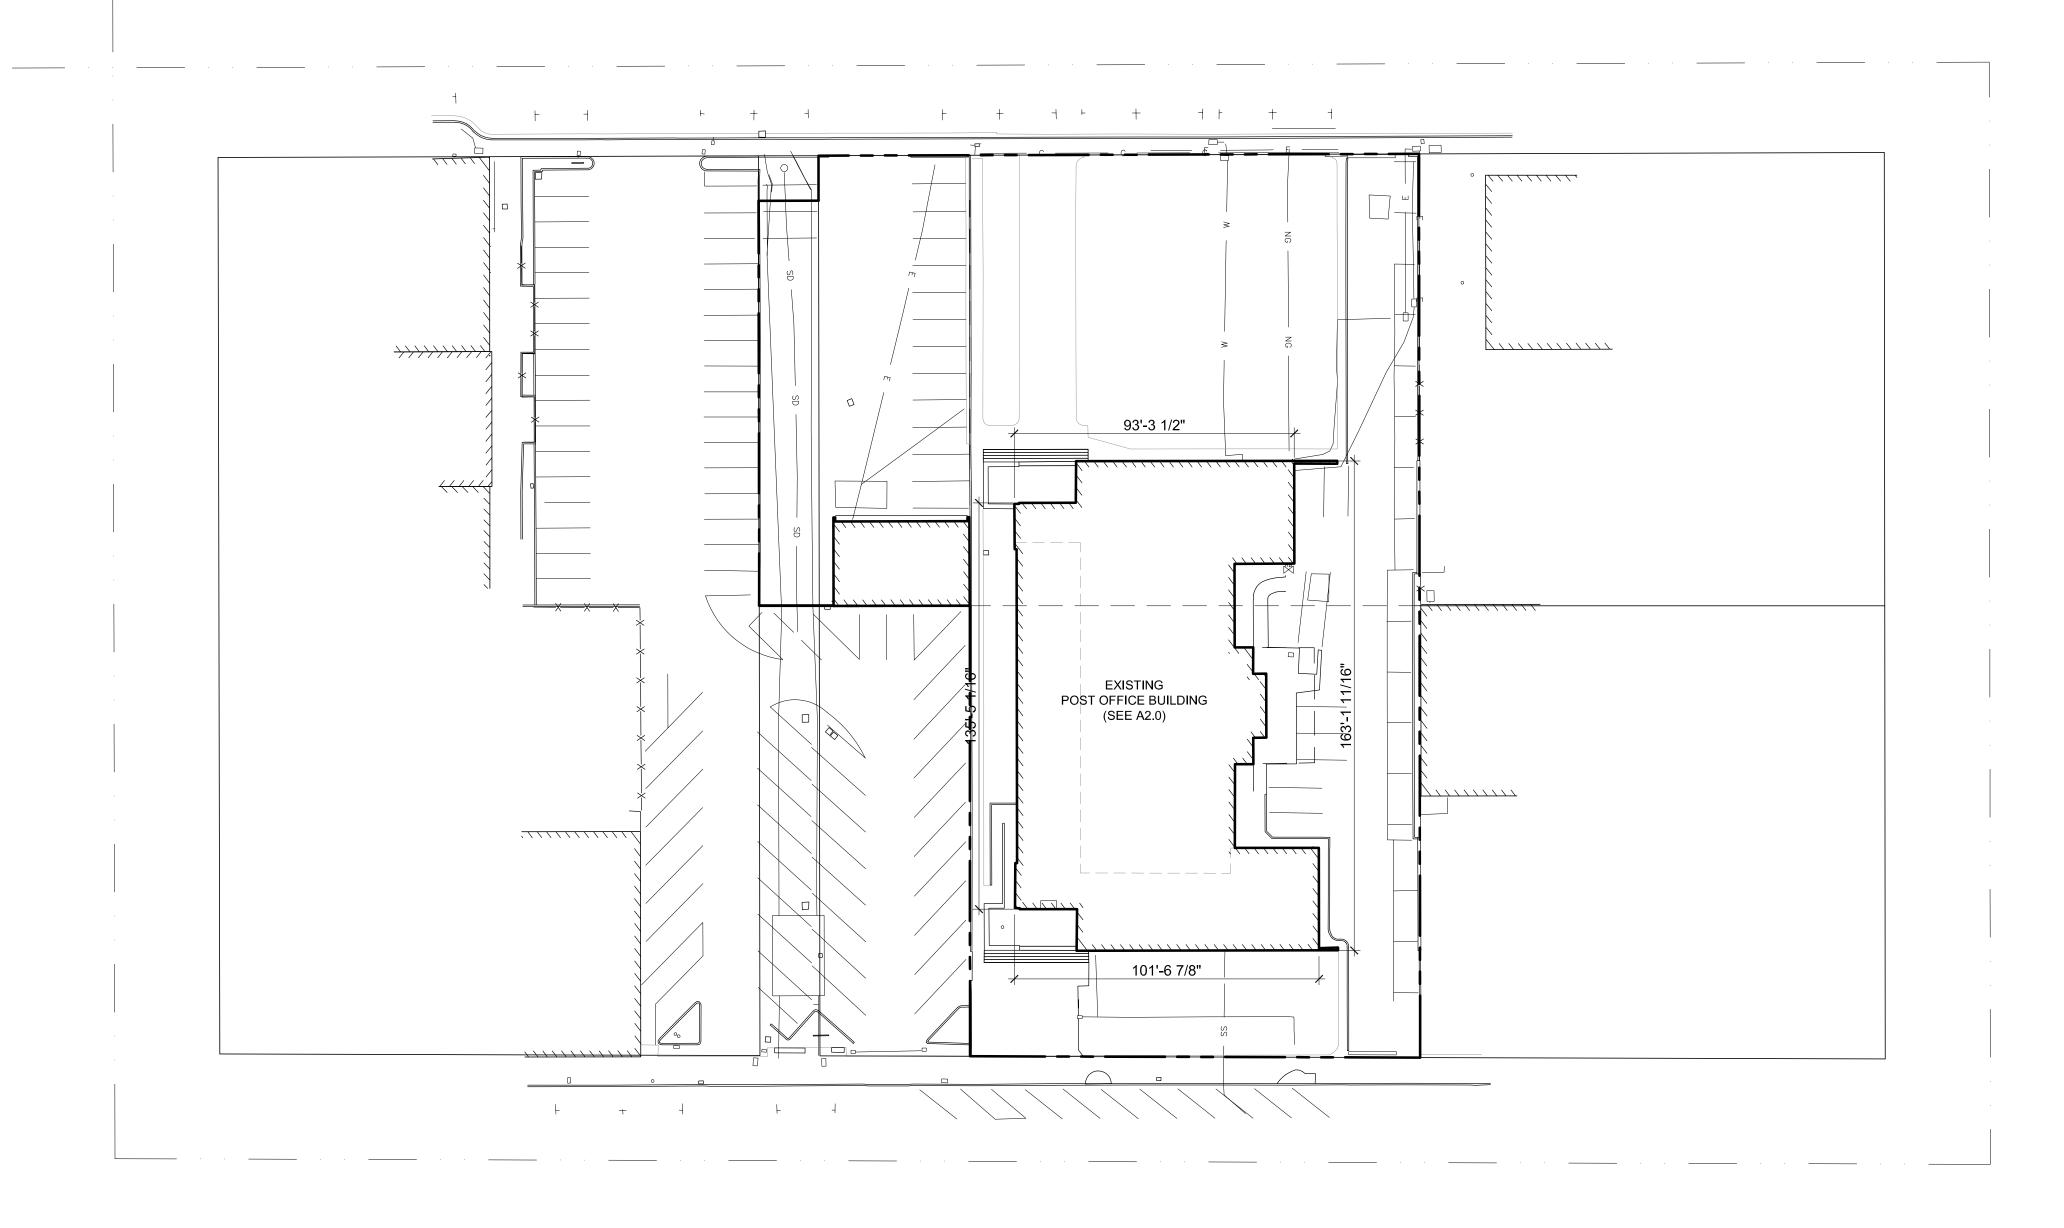

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ISSUES AND REVISIONS
DESCRIPTION

03.30.2020 PLANNING SUBMITTAL

PROJECT NUMI

EXISTING SITE PLAN


SC

1"=32'-0"





A10

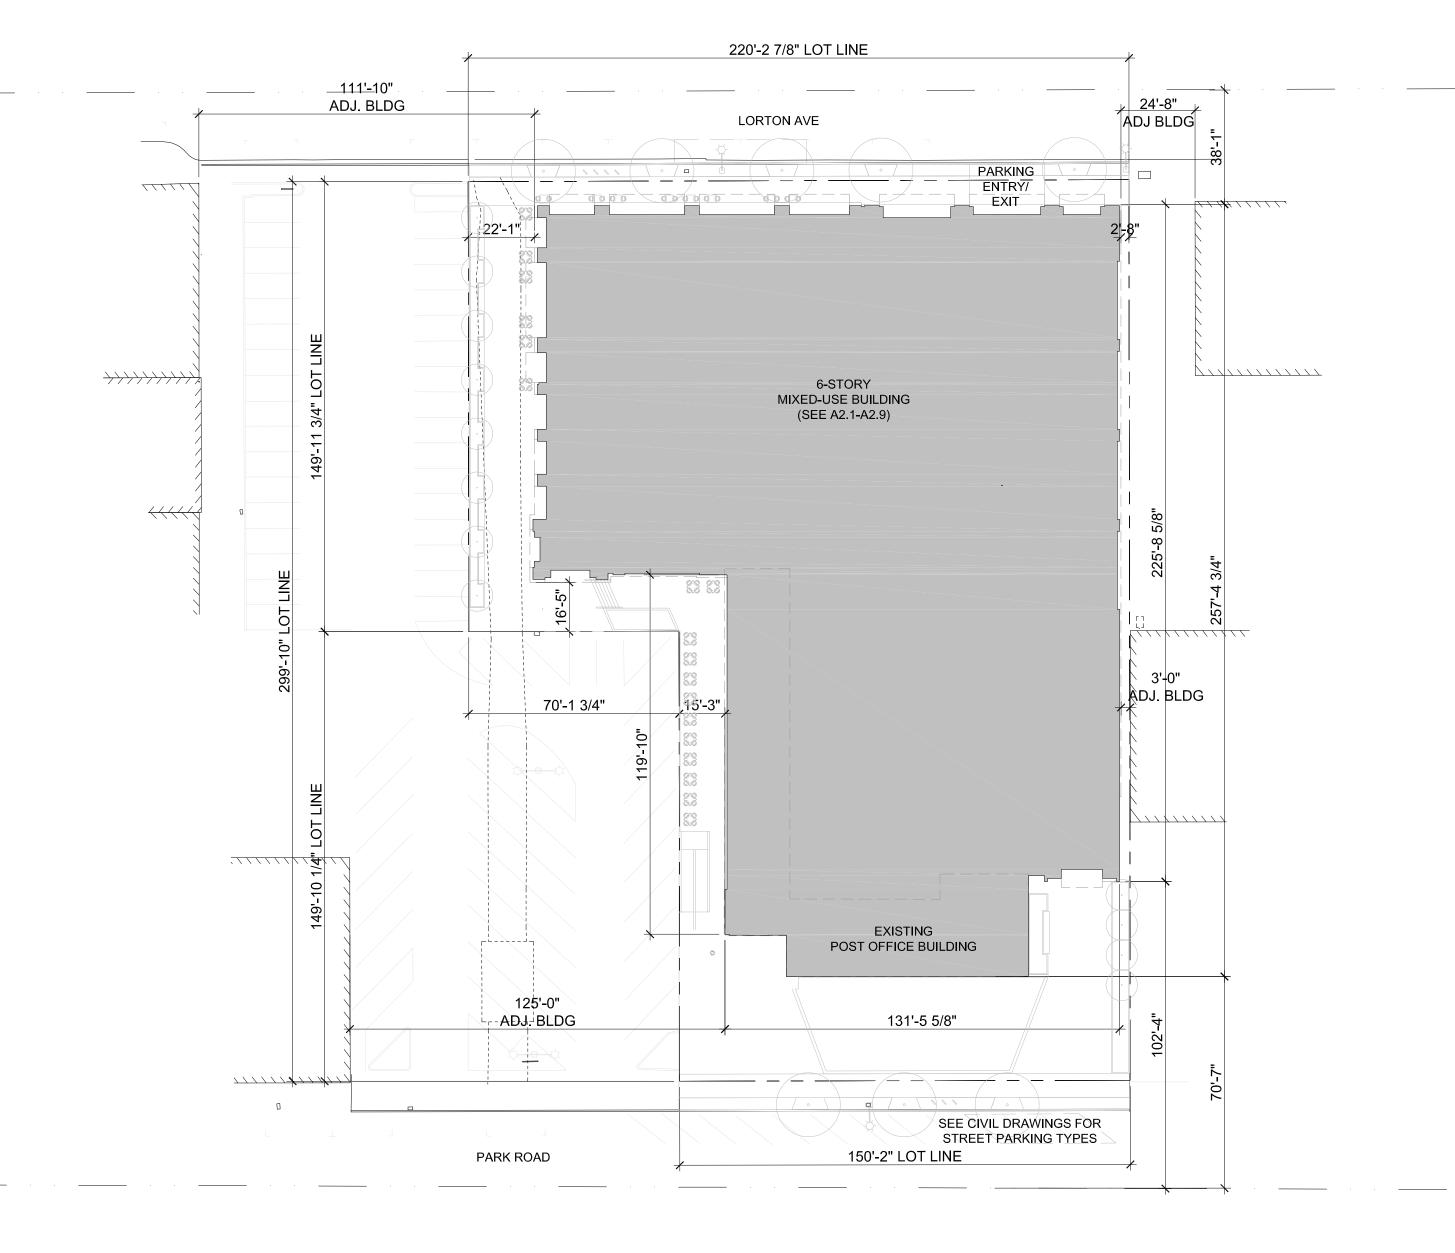

APPLICABLE CODES

THE GENERAL CONTRACTOR IS RESPONSIBLE FOR COMPLETING THE CONSTRUCTION OF THIS PROJECT IN ACCORDANCE WITH THE FOLLOWING FEDERAL, STATE AND LOCAL CODES, INCLUDING THEIR MOST RECENT AMENDMENTS AND REVISIONS.

THE CITY OF BURLINGAME ADOPTS THE FOLLOWING CODES, ORDINANCES, RULES AND REGULATIONS (INCLUDING ERRATA AND SUPPLEMENTS OF THE BELOW

A. 2019 CALIFORNIA BUILDING CODE B. 2019 CALIFORNIA ELECTRICAL CODE C. 2019 CALIFORNIA MECHANICAL CODE D. 2019 CALIFORNIA PLUMBING CODE E. 2019 CALIFORNIA ENERGY CODE F. 2019 CALIFORNIA FIRE CODE G. AMENDMENTS ADOPTED IN ORDINANCE 1889 H. 2019 CALIFORNIA HISTORICAL BUILDING CODE FOR

REGULATIONS J. 2019 CA BUILDING ENERGY EFFICIENCY STANDARDS (

PROJECT DATA

PROJECT DESCRIPTION: 220 PARK ROAD APN: 029-204-250 ZONING: HMU

> THE PROJECT CONSISTS OF AN OFFICE BUILDING OVER A PARKING STRUCTURE AND A PORTION OF THE EXISTING POST OFFICE. THE PARKING STRUCTURE HAS 2 BELOW GRADE LEVELS AND 1 LEVEL AT GRADE. THE BUILDING CONSISTS OF 5 OFFICE FLOORS (FLOORS 2-6) AND A GROUND FLOOR CONSISTING OF LOBBY, PARKING, AND RETAIL FUNCTIONS.

NO PUBLIC MONEY WILL BE USED TO CONSTRUCT THE PROJECT.

PORTION OF EXISTING STRUCTURE/ POST OFFICE I. ALL OTHER STATE AND LOCAL ORDINANCES AND

PLANNING INFORMATION

. TOTAL SITE COVERAGE 54,956 GSF EXISTING FOOTPRINT: 4,840 GSF **BUILDING FOOTPRINT:** 39,300 GSF 44,140 GSF TOTAL FOOTPRINT 44,140 / 54,956 (80.3%) TOTAL LOT COVERAGE:

TOTAL GROSS FLOOR AREA (PROPOSED BLDG.) GROUND FLOOR: 39,300 GSF 31,533 GSF SECOND FLOOR: THIRD FLOOR: 28,538 GSF FOURTH FLOOR: 28,666 GSF FIFTH FLOOR: 27,235 GSF SIXTH FLOOR: 23,915 GSF TOTAL: <u>179,187</u> GSF

TOTAL GROSS SQUARE FOOTAGE (EXISTING BLDG.) GROUND FLOOR: 4,840 GSF

4,840 GSF

L COMMERCIAL FLOOR AREAS (PROPOSED BLDG.)

SECOND FLOOR: 31,533 GSF THIRD FLOOR: 28.538 GSF FOURTH FLOOR: 28,666 GSF FIFTH FLOOR: 27,235 GSF SIXTH FLOOR: 23,915 GSF TOTAL: 139,887 GSF EXIST. GROUND FLOOR: 4,840 GSF PROP. GROUND FLOOR 7,562 GSF <u>12,402</u> GSF

TOTAL GROSS SQUARE FOOTAGE (ALL) **TOTAL GSF** 179,187 GSF 54,956 GSF 179,187 GSF BUILDING: TOTAL F.A.R. PROPOSED: 3.26

TOTAL BUILDING HEIGHT

BASED ON AVERAGE TOP OF CURB= 34.31' CIVIL ELEV (ARCH ELEVATION)

ROOF SCREEN 132.81' (98'-6") ROOF 120.81' (86'-6") 6TH FLOOR 106.81' (72'-6") 5TH FLOOR 92.81' (58'-6") 4TH FLOOR 78.81' (44'-6") 3RD FLOOR 64.81' (30'-6") 2ND FLOOR 50.81' (16'-6") **GROUND AT** (E) POST OFFICE 41.643' (5'-4") GROUND AT OFFICE ENTRY 36.31' **GROUND AT** GARAGE ENTRY 34.31' B1 LEVEL 22.81' (- 11'-6") 12.31' B2 LEVEL (- 22'-0")

TOTAL PARKING SPACES REQUIRED COMMERCIAL: 280 STALLS

> (139,887 GSF) (2.0 /1,000 SF)

TOTAL PARKING SPACES PROVIDED

TOTAL REQUIRED:

LEVEL P2 (BELOW GRADE): 134 STALLS LEVEL P1 (BELOW GRADE): 132 STALLS GROUND FLOOR: STALLS

280 STALLS

TOTAL PROVIDED: 283 STALLS ACCESSIBLE STALLS PER CBC 11B-208.2 & CBC 2019 11B-208.2.4:

ACCESSIBLE VAN STALL ACCESSIBLE STANDARD STALL ACCESSIBLE VAN EV STALL ACCESSIBLE STANDARD EV STALL TOTAL ACCESSIBLE STALLS=

CAV/ EV STALLS PER CALGREEN 5.106.5.2 283 X 8%= 23 STALLS TOTAL EV CHARGERS PER CALGREEN 5.106.5.3.3.& CBC 11B-228.3.2.1: 283 X 6%= 17 STALLS (SEE EV ACCESSIBLE ABOVE) TOTAL CAV= 6 STALLS TOTAL EV= 17 STALLS

PER LEED GREEN VEHICLE STALLS 283 X 5%= 14 STALLS

BICYCLE PARKING PER CALGREEN 5.106.4.1.2 283 X 5%= 15 SHORT TERM BICYCLE RACKS 283 X 5%= 15

LONG TERM BICYLE LOCKERS (SEE A2.3 FOR BIKE STORAGE ROOM)

CONSTRUCTION HOURS

WEEKDAYS: 8:00 AM- 7:00 PM **SATURDAYS: 9:00 AM-6:00 PM** SUNDAYS AND HOLIDAYS: NO WORK ALLOWED (SEE CITY OF BURLINGAME MUNICIPAL CODE. SECTION 18.07.10 & 13.04100 FOR DETAILS)

CONSTRUCTION HOURS IN THE CITY PUBLIC RIGHT-OF-WAY ARE LIMITED TO WEEKDAYS AND NON-CITY HOLIDAYS BETWEEN 8:00 AM AND 5:00 PM.

CODE ANALYSIS

B, S-2, A-2, A-3 USE AND OCCUPANCY NON-SEPARATED OCC. PER CBC 508.3.

CONSTRUCTION TYPE I-B, FULLY SPRINKLERE

ALLOWABLE HEIGHT & AREA PER CBC 504 &505 TABULATED MAX HEIGHT: 12 STORIES / 180'-0" TABULATED MAX AREA/FLR: UNLIMITED (A-2/A-3,B) 237,000 SF (S-2)

PROPOSED HEIGHT & AREA STORIES ABOVE GRADE: 6 STORIES MAXIMUM HEIGHT: 86'-6" (ROOF) HIGHEST OCCUPIED FLOOR IS 72'-6" ABOVE LOWEST LEVEL OF FIRE DEPARTMENT VEHICLE ACCESS (GRADE EL. 33.26')

SEE PLANNING INFO #2 AREA PER FLOOR:

CONSTRUCTION FOR TYPE-IB (PER TABLE 601) PRIMARY STRUCTURAL FRAME: 2HR BEARING WALLS: EXTERIOR: 2 HR INTERIOR: 2 HR NON-BEARING WALLS AND PARTITIONS (INTERIOR):

FLOOR CONSTRUCTION AND SECONDARY MEMBERS: 2 HR

ROOF CONSTRUCTION AND SECONDARY MEMBERS: FIRE SEPARATION DISTANCE

FIRE RESISTANCE REQUIREMENTS FOR EXTERIOR WALLS BASED ON FIRE SEPARATION DISTANCE (CBC TABLE 602): X< 5: 1HR 5<= X <10: 1HR 10<= X <30: 1 HR

X>= 30: 0 HR PROVIDED FIRE SEPARATION DISTANCE: PARK ROAD: 70'-7" (CENTERLINE OF STREET) LORTON AVE: 38'-1" (CENTERLINE OF STREET) LEFT SIDE: 22'-1" (INTERIOR LOT LINE)*

RIGHT SIDE: 2'-8" (INTERIOR LOT LINE) ** * WHERE TABLE 705.8 PERMITS NONBEARING EXTERIOR WALLS UNLIMITED AREA OF UNPROTECTED OPENINGS, THE REQUIRED FIRE- RESISTANCE RATING FOR THE EXTERIOR WALLS IS 0 HOURS.

** 1 HOUR RATED EXTERIOR WALL PROVIDED ALONG RIGHT ELEVATION

G. REQUIRED OPENING PROTECTION

REQUIRED EXTERIOR WALL AND OPENING PROTECTION (CBC TABLE 705.8) MAX. AREA OF EXTERIOR WALL OPENINGS BASED ON FIRE SEPARATION DISTANCE AND DEGREE OF OPENING PROTECTION:

0 TO LESS THAN 3 FEET= UNPROTECTED AND SPRINKLERED AREA NOT PERMITTED 15 TO LESS THAN 20 FEET= UNPROTECTED AND SPRINKLERED AREA 75% 20 TO LESS THAN 25 FEET= UNPROTECTED AND SPRINKLERED AREA NO LIMIT

MIXED USE OCCUPANCY CALCULATION: FOR A-2, A-3, B- OCCUPANCIES, AREA, HEIGHT, AND NUMNER OF STORIES IS UNLIMITED

MIXED OCC. DETERMINATION PER SEC. 506.2.4: S-2 OCC: 14,700/237,000 = 0.062 < 3

THE TOTAL PROPOSED BUILDING AREA IS LESS THAN THE ALLOWABLE AREA OF GROUP S-2 OCCUPANCY. THIS ALLOWS FOR THE APPLICATION OF THE NON-SEPARATED USE PROVISIONS TO ELIMINATE THE OCCUPANCY SEPARATION BETWEEN THE GROUP S-2 OCCUPANCIES AND THE GROUP A AND B OCCUPANCY

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ISSUES AND REVISIONS NO. DATE DESCRIPTION 03.30.2020 PLANNING SUBMITTAL

06.22.2020 PLANNING RESUBMITTAL #1

PROJECT NUMBER

SHEET TITLE


SCALE

PROPOSED SITE PLAN

1"=32'-0"

SHEET NUMBER

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(A) 06.17.2020 PLANNING SUBMITTAL

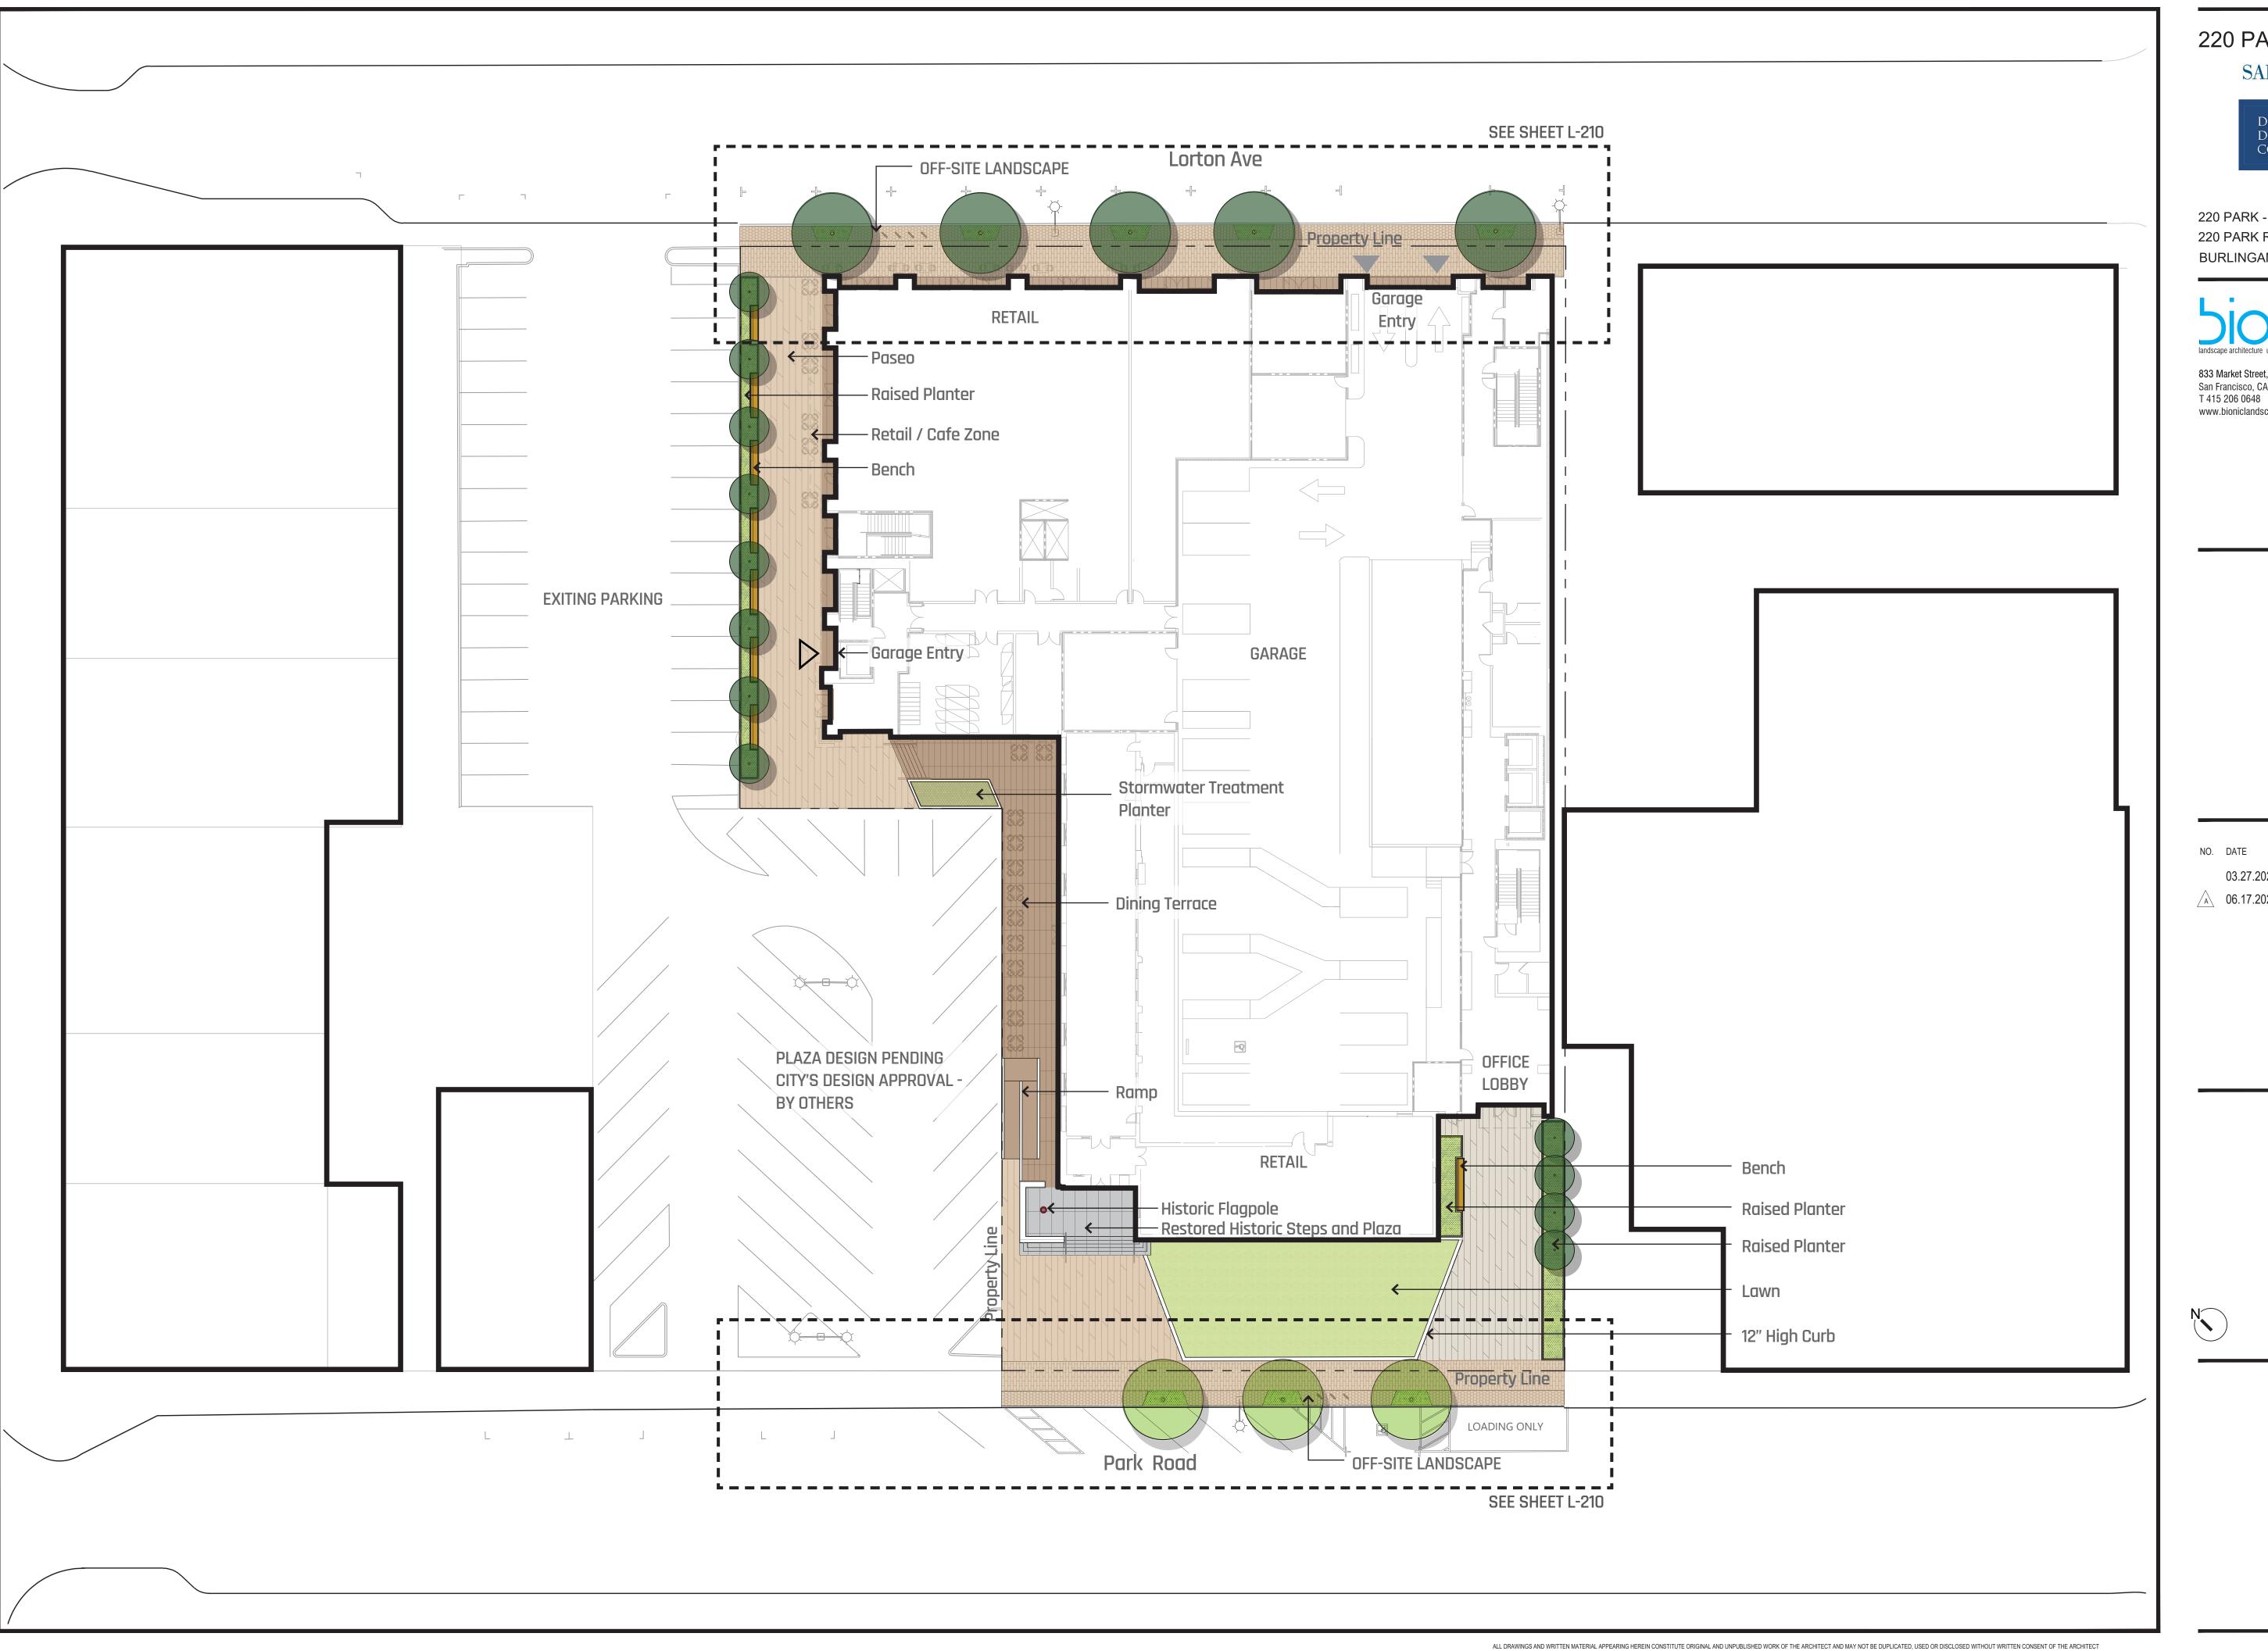PROJECT NUMBER 19034


SHEET TITLE

ILLUSTRATIVE SITE PLAN

SHEET NUMBER

SCALE 1" = 20'

L-201

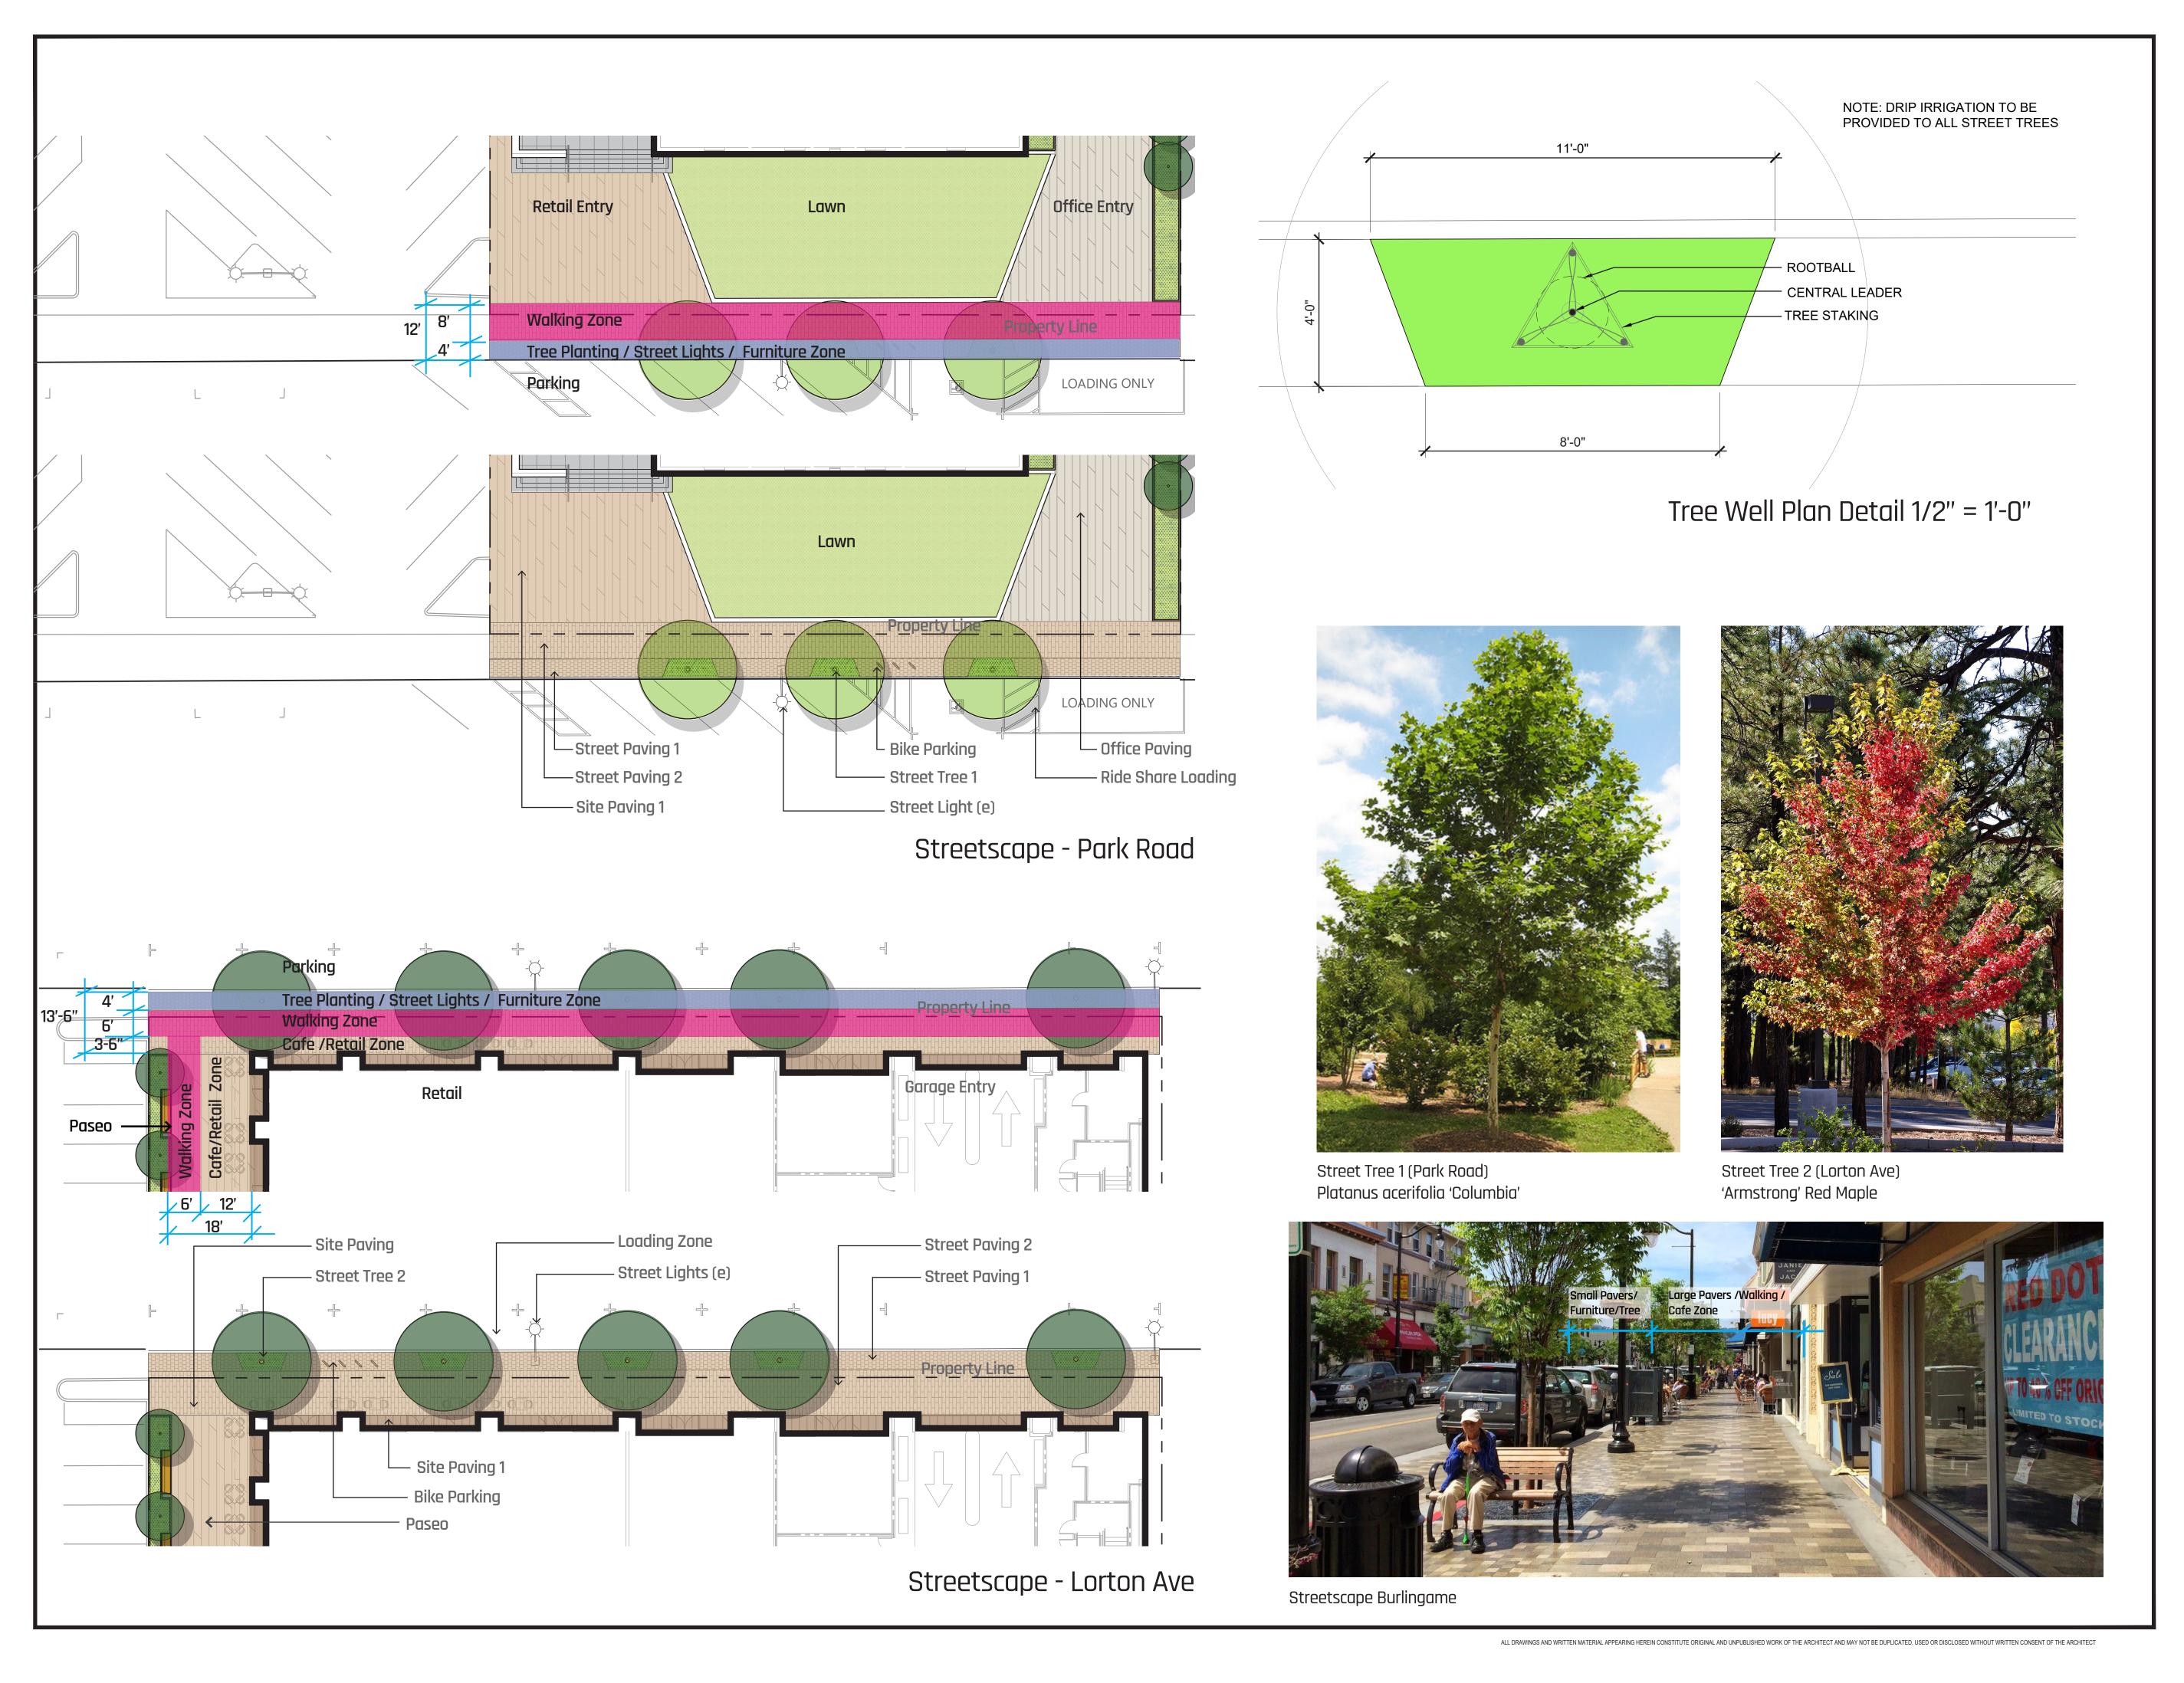

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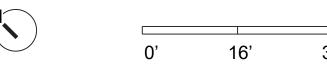
A 06.17.2020 PLANNING SUBMITTAL

PROJECT NUMBER 19034

SHEET TITLE
STREETSCAPE LAYOUT AND
MATERIAL

SCALE 1/16"= 1'

SHEET NUMBER



L-210

Lorton Ave Planter C— Stormwater Treatment Planter A Stormwater Treatment Planter B Planter B – LEGEND LAWN $/\!\!/$ Planter A $-\!\!\!-$ PASEO PLANTER PARK RD PLANTERS $\langle \langle \rangle \rangle \langle \rangle \langle \rangle$ LOADING ONLY STREETSCAPE PLANTING Park Road STORMWATER TREATMENT PLANTER


PLANT LIST

			Nother on	5		Water
			Native or	Evergreen/		Requirement
Symbol	Botanical Name	Common Name	Adaptive	Deciduous	Size	WUCOLS
	Entry Planters (Planters A & B)		T			
Со	Cercis texensis 'Oklahoma'	Redbud	Native	Deciduous	24" Box	L
La	Lavandula angustifolia 'hidcote blue'	Hidcote Blue English Lavender	Adaptive	Evergreen	1 gal	L
Pa	Pennisetum alopecuroides 'hameln'	Hameln Dwarf Fountain Grass	Adaptive	Deciduous	1 gal	L
Se	Sesleria autumnalis	Autumn Moor Grass	Adaptive	Evergreen	1 gal	M
Sgp	Salvia greggii x 'Purple'	Purple Autumn Sage	Native	Evergreen	1 gal	L
Sgu	Salvia greggii x 'Ultra Violet'	Ultra Violet Hybrid Autumn Sage	Native	Evergreen	1 gal	L
Paseo Pl	anter (Planter C)					
Ар	Acer Palmatum 'Sangu Kaku'	Sangu Kaku Japanese Maple	Adaptive	Deciduous	24" Box	М
Nd	Nandina domestica 'Gulf Stream'	Gulf Stream Heavenly Bamboo	Adaptive	Evergreen	5 gal	L
Pt	Pittosporum tenuifolium 'Oliver Twist'	Oliver Twist Pittosporum	Adaptive	Evergreen	5 gal	М
- Stormwa	lter Treatment Planters (Stormwater Treatme	nt Planters A & B)				
Ctu	Chondropetalum tectorum 'El Campo'	Small Cape Rush	Adaptive	Evergreen	1 gal	L
ld	Iris douglasiana	Douglas Iris	Native	Evergreen	1 gal	L
Jp	Juncus patens 'Elk Blue'	Common Rush	Native	Evergreen	1 gal	L
Streetsca	ape Planting					
Di	Dietes vegeta	Fortnight Lily	Adaptive	Evergreen	1 gal	L
Park Rd S	Street Tree					
Ar	Acer rubrum 'Armstrong'	Columnar Red Maple	Adaptive	Deciduous	36" box	М
orton A	ve Street Tree					
Pa	Platanus acerifolia 'Columbia'	L andan plana traa	Adaptive	Deciduous	36" box	M
га	Tiatanus aceniona Columbia	London plane tree	Auaptive	Inecianons	I 30 DOX	<u>IVI</u>
Lawn						
Fa	Festuca arundinacea	Tall Fescue	Adaptive	Evergreen	Sod	Н

Sesleria autumnalis

Salvia greggii

TREE AND PLANT IMAGES

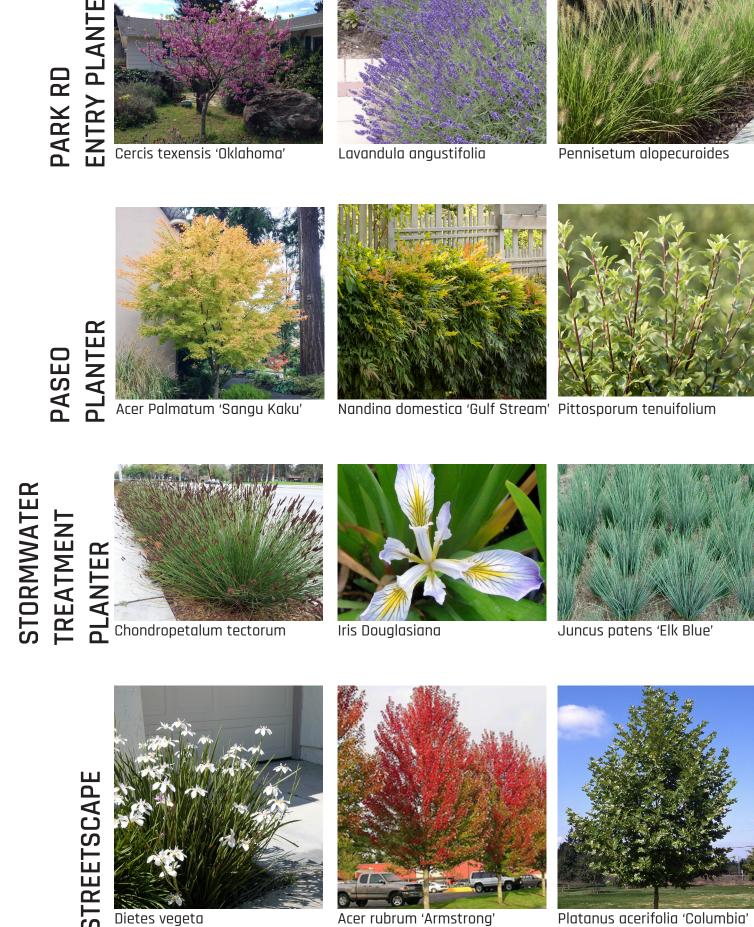

NOTES:

- 1. ALL PLANT GROUPS ARE DESIGNED FOR LOW WATER USE AND LAID OUT BY HYDROZONES.
- 2. THIS PROJECT SHALL UTILIZE A DRIP IRRIGATION IN PLANTING AREAS.
- 3. THE HISTORIC LAWN WILL BE IRRIGATION USING SPRINKLERS.
- 4. PROJECT WILL MEET APPLICABLE WATER CONSERVATION IN LANDSCAPE REGULATIONS (WELO).
- 5. TREE REMOVAL PERMIT WILL BE ACQUIRED FROM PARKS DIVISION PRIOR TO REMOVAL OF EXISTING TREES
- OVER 48 INCHES IN CIRCUMFERENCE AT 54 INCHES FROM BASE OF TREE.

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ISSUES AND REVISIONS

NO. DATE DESCRIPTION

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(A) 06.17.2020 PLANNING SUBMITTAL

PROJECT NUMBE

SHEET TITLE
PLANTING PLAN

SCALE 1" = 20'

0' 10' 2



L-401

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Material Context














Material Precedents



Street Paving 1 (Burlingame Ave Paver)



Street Paving 2 (Burlingame Ave Paver)

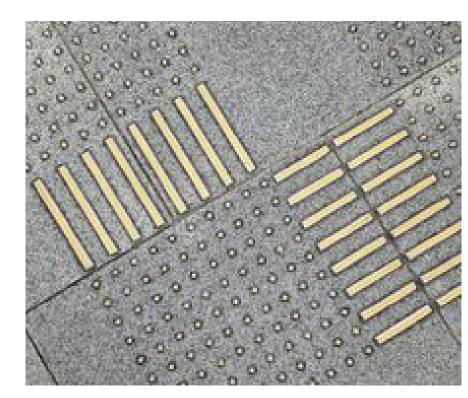

Site Paving with Brass Inlay



Site Paving with Brass Inlay



Site Paving with Brass Inlay



Site Lighting



Planter



Planter with Seating



Planter with Seating



Lighted Handrails

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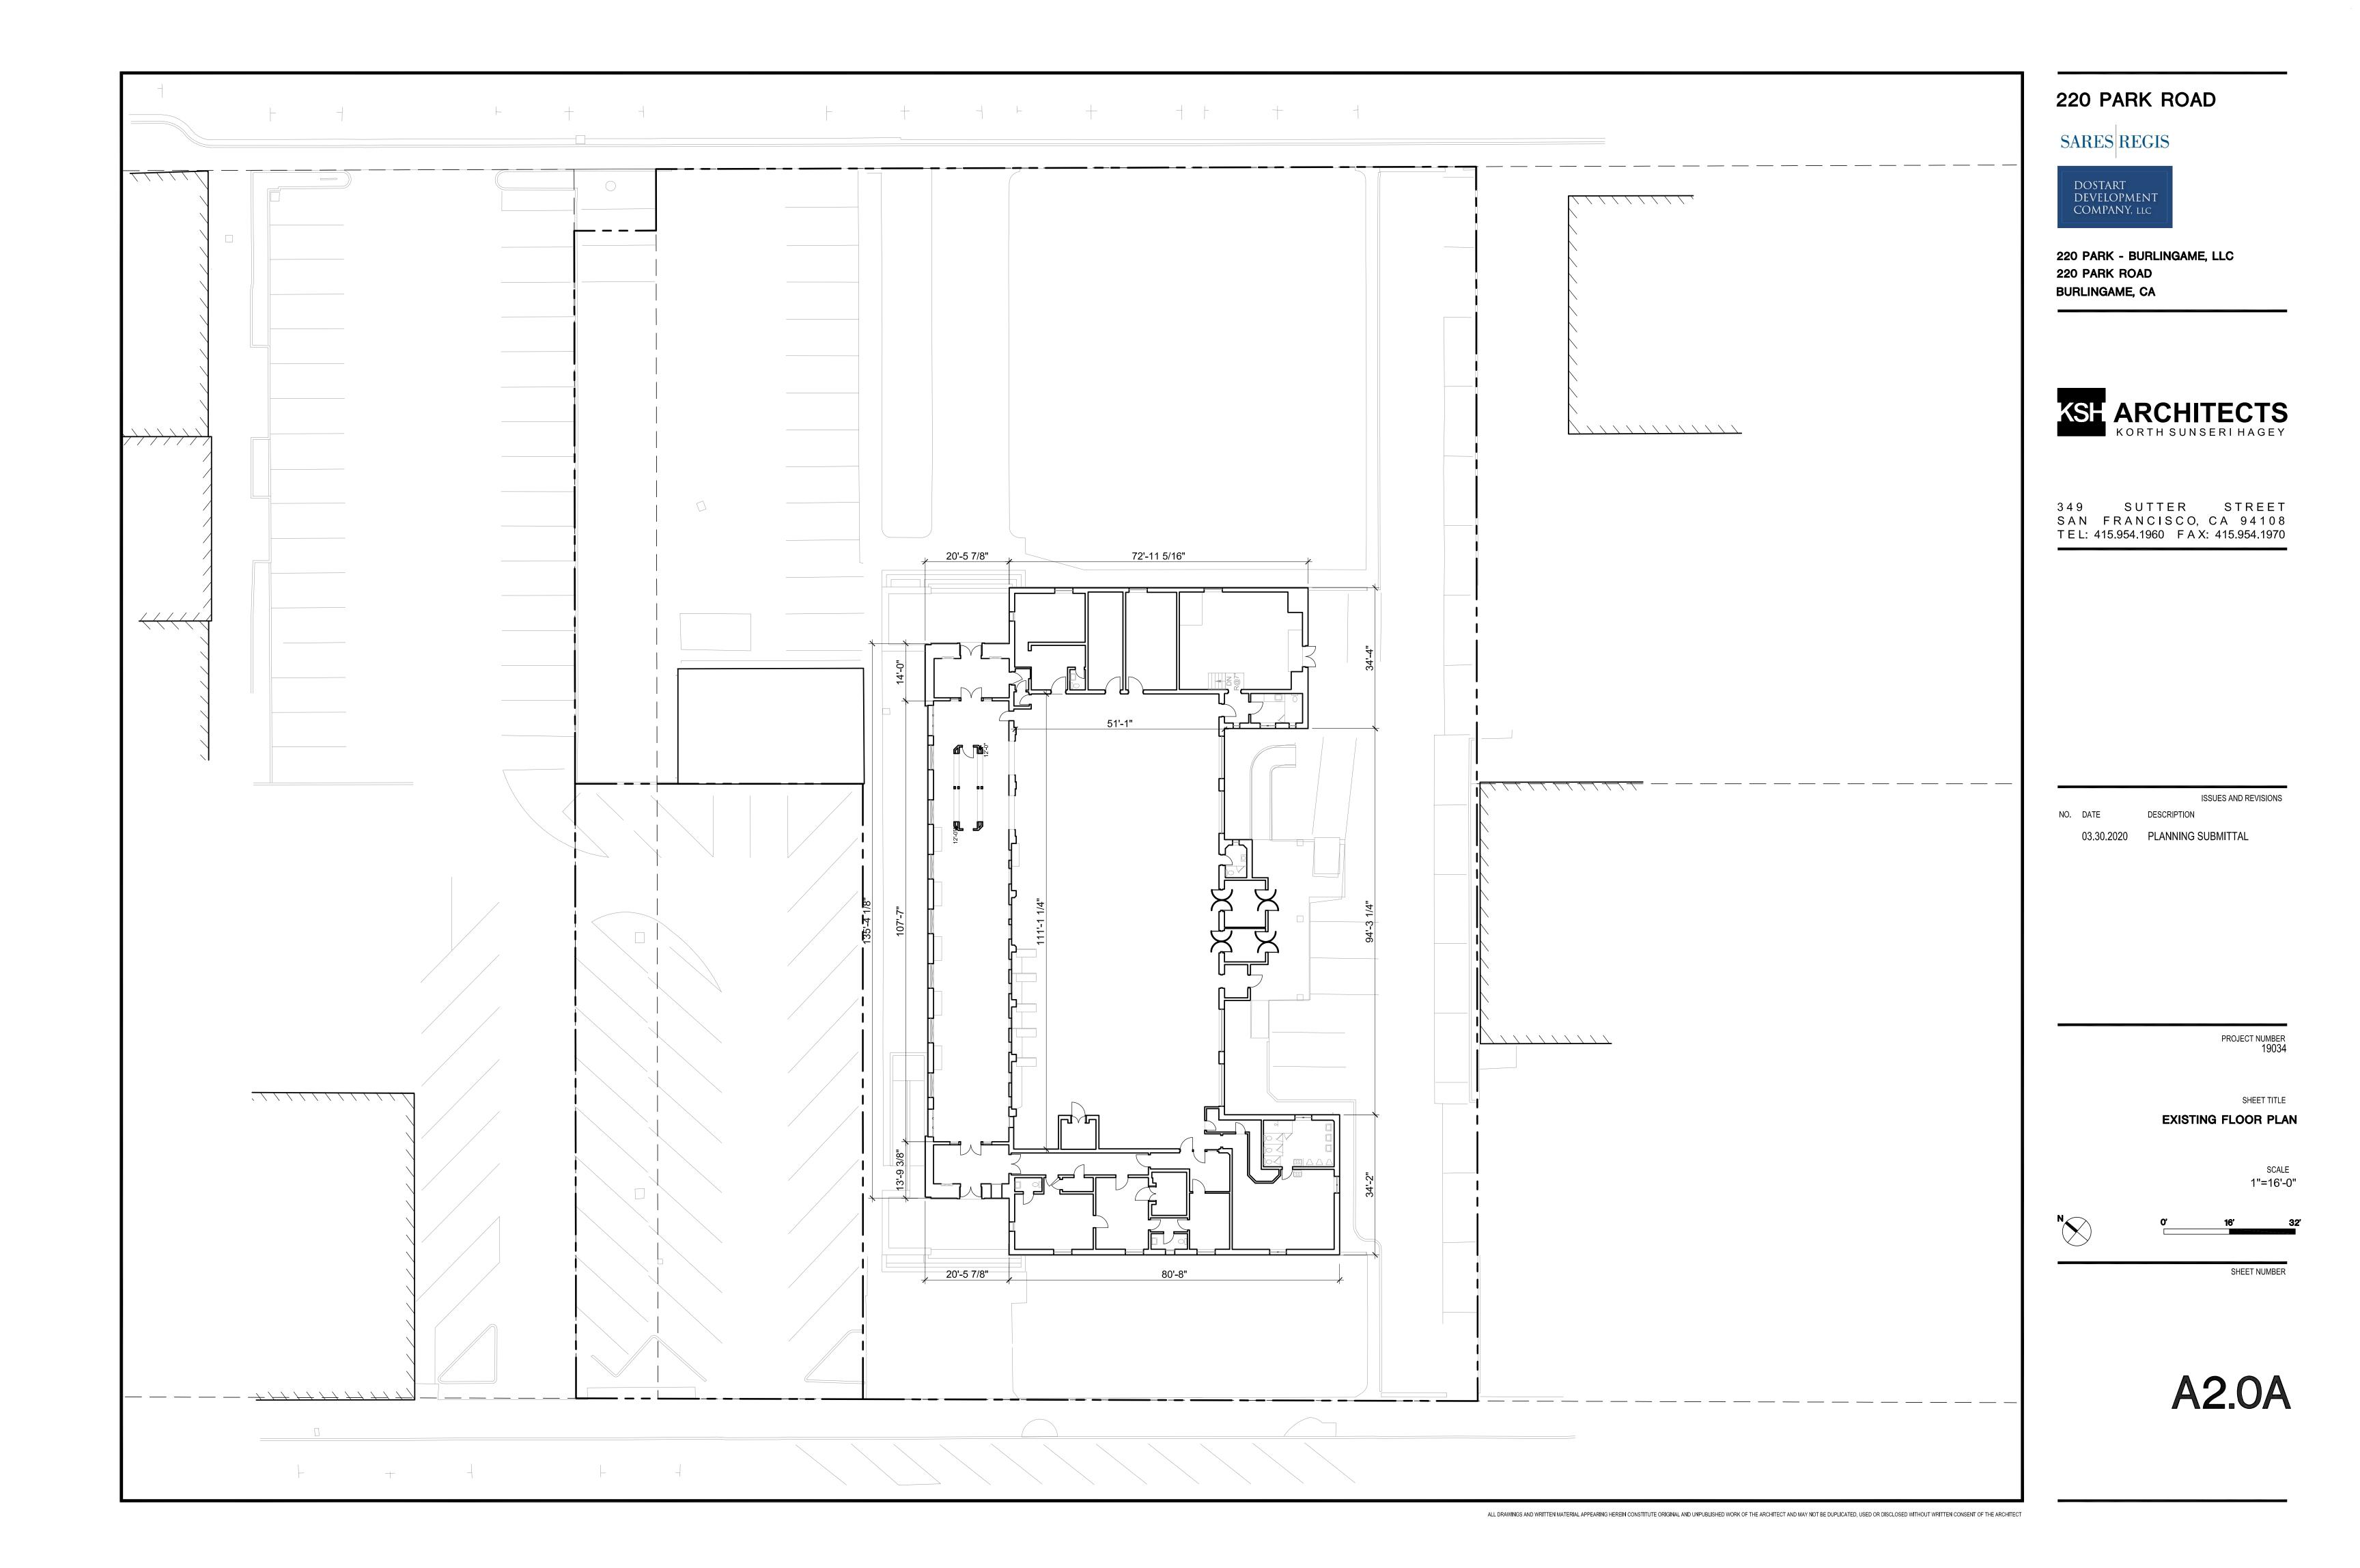
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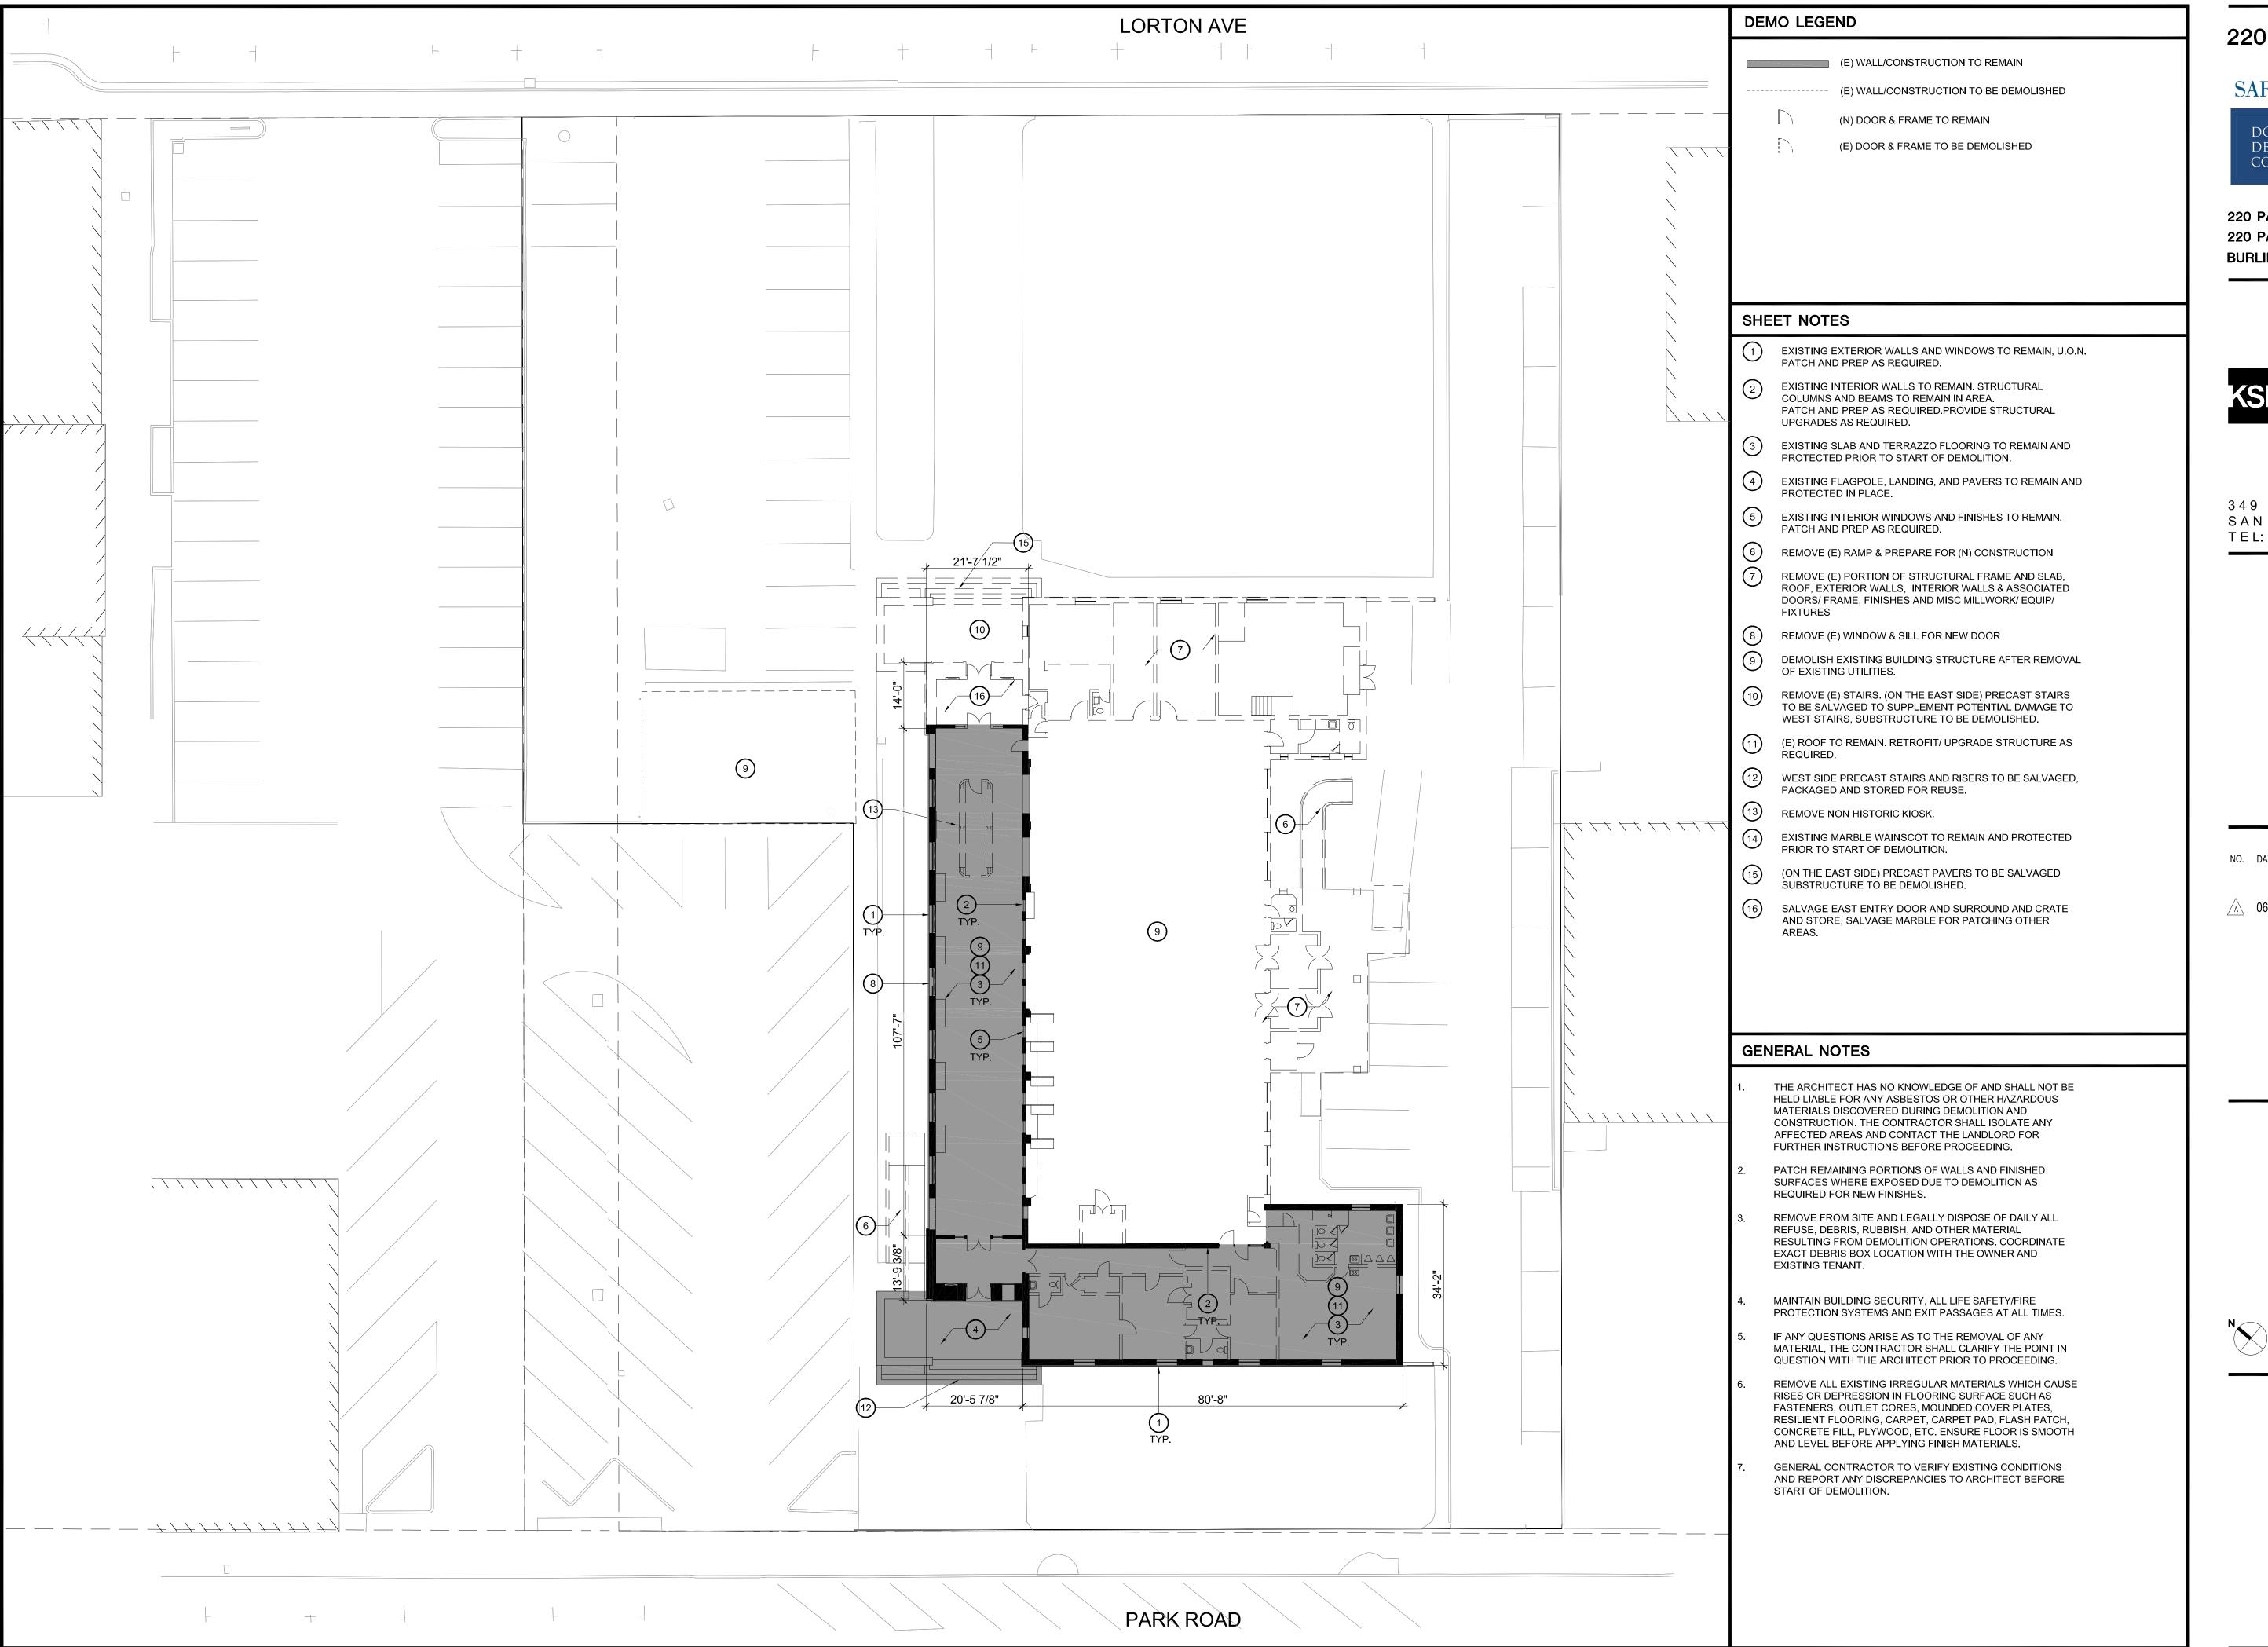
SHEET TITLE
MATERIALS CONTEXT AND
PRECEDENTS

NTS

SHEET NUM

L-601





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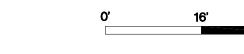
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PROJECT NUMBER

SHEET TITLE


DEMO FLOOR PLAN

1"=16'-0"



SHEET NUMBER

(A2.0B)

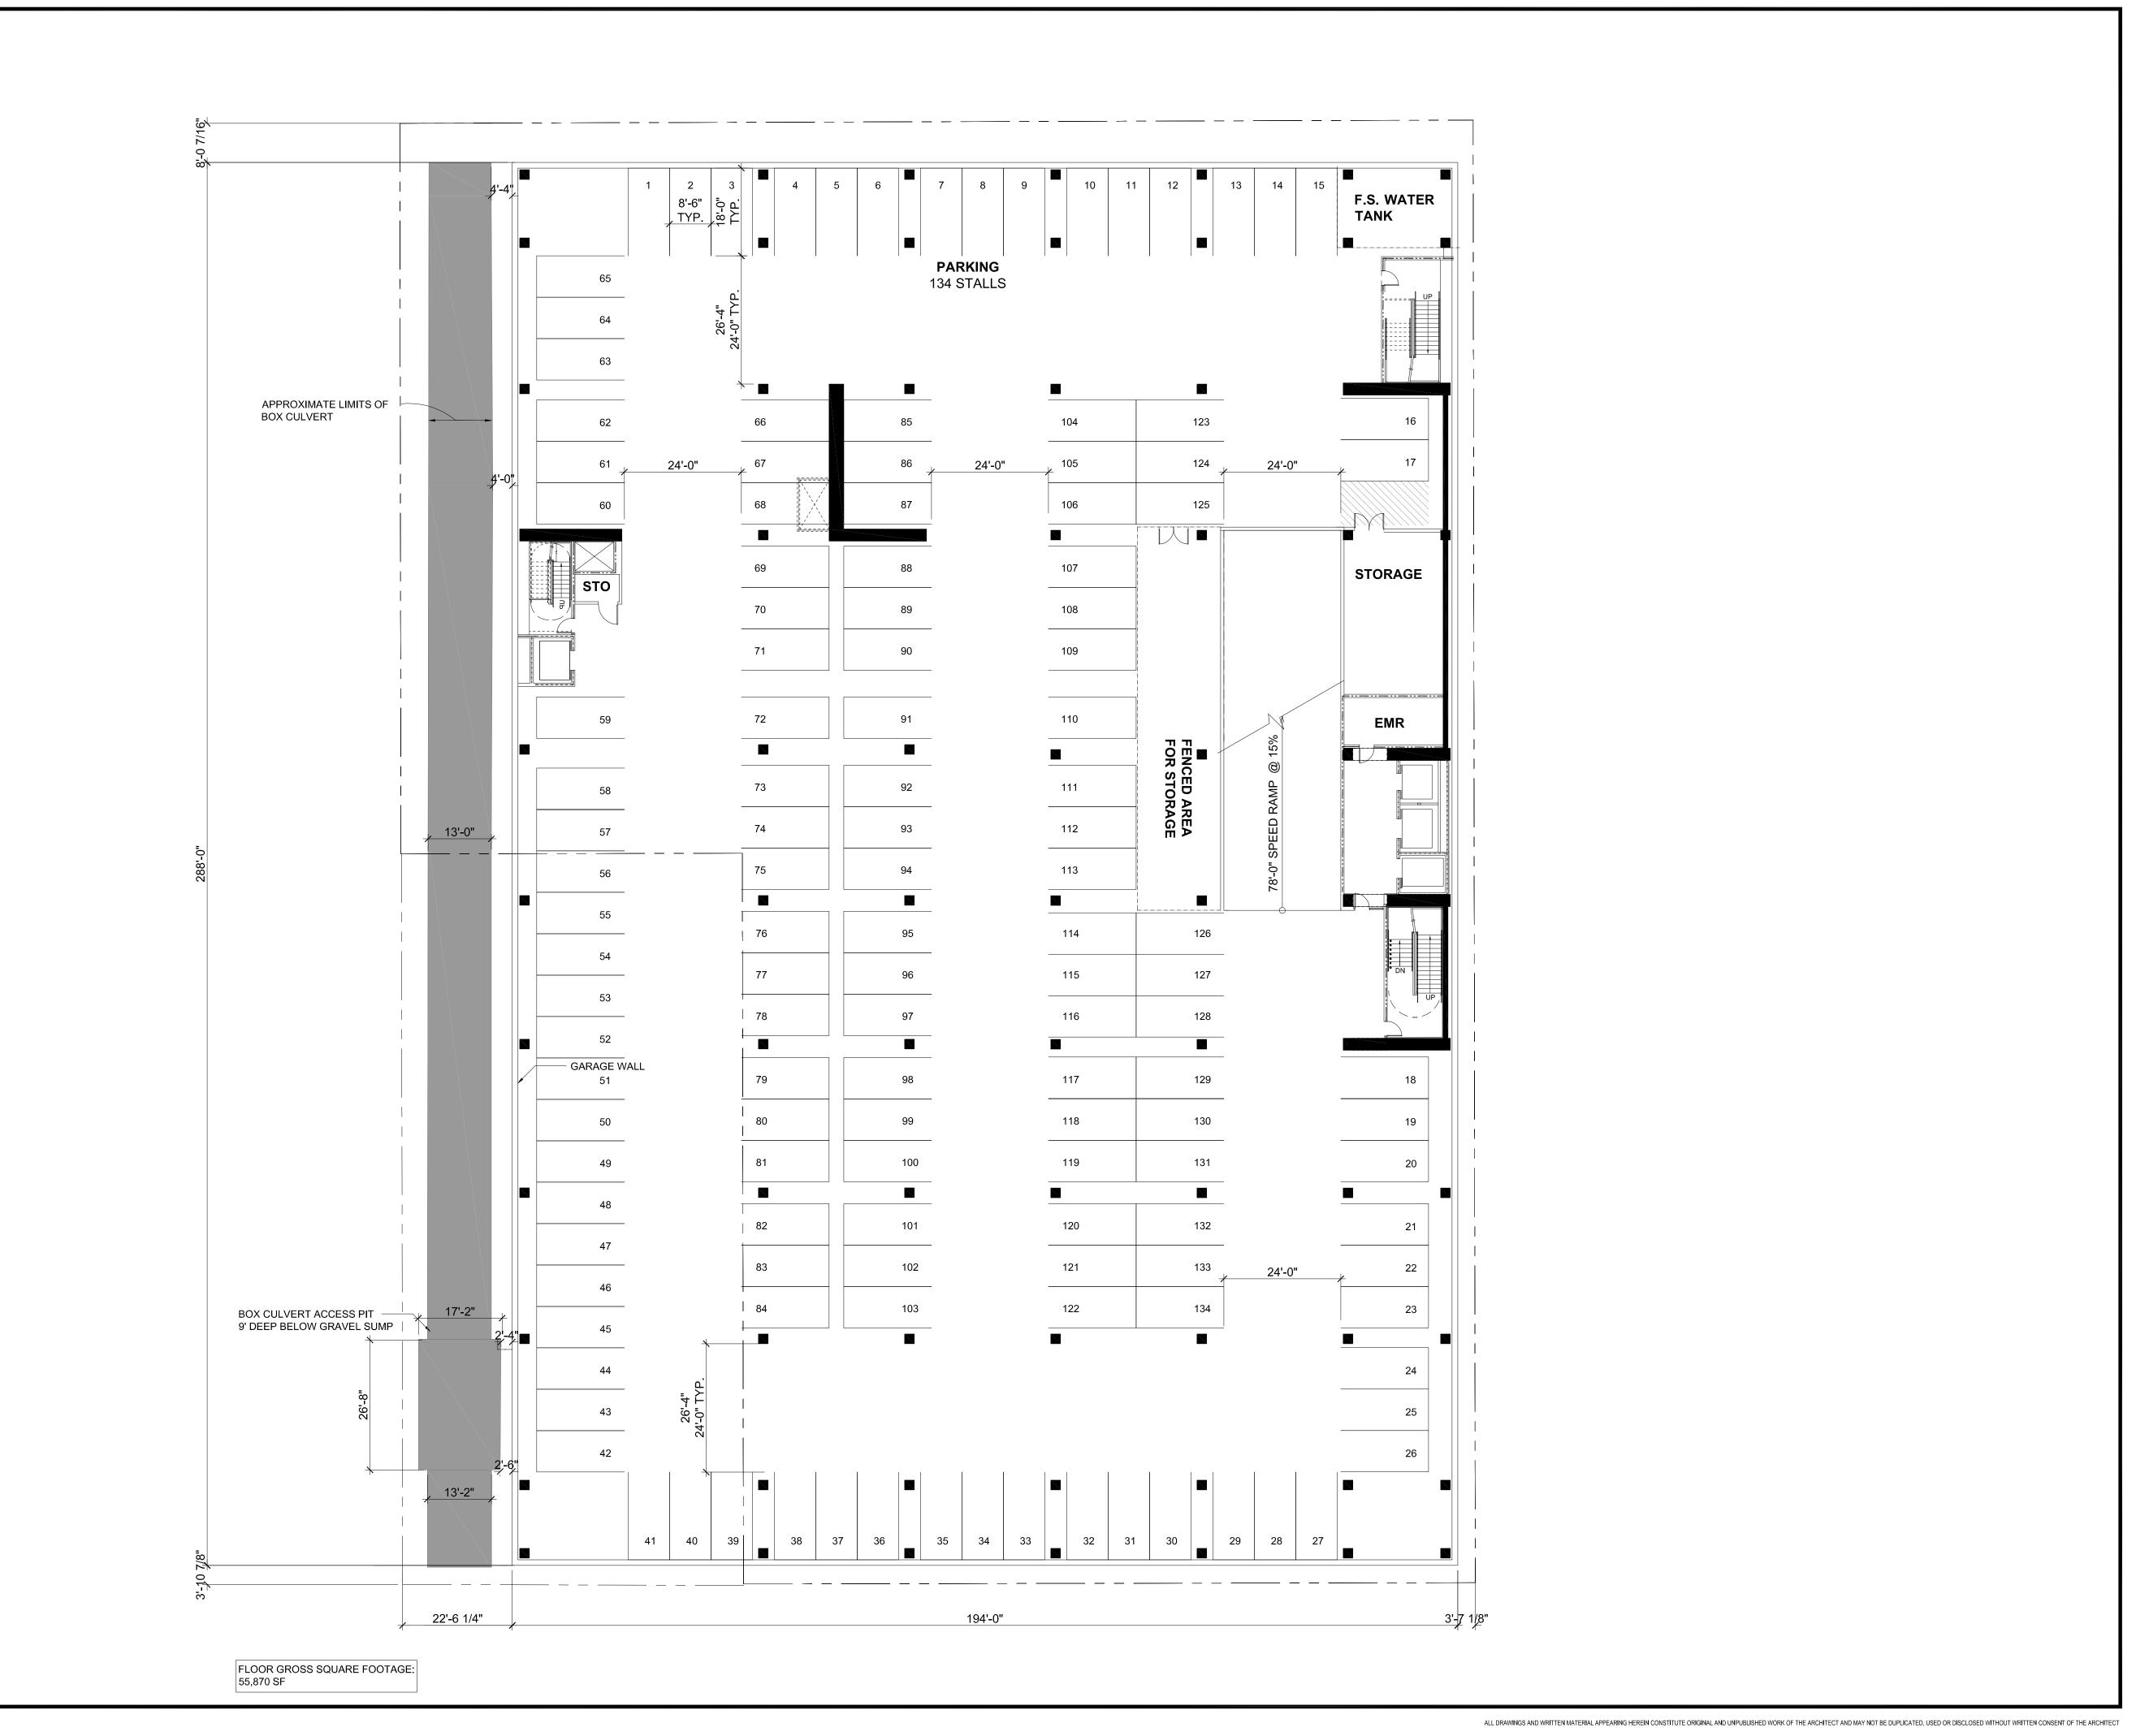

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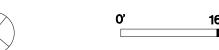
△ 06.22.2020 PLANNING RESUBMITTAL #1

PROJECT NUM

SHEET TITLE

BELOW GRADE PARKING LEVEL 2


SCALE 1/16"=1'-0"









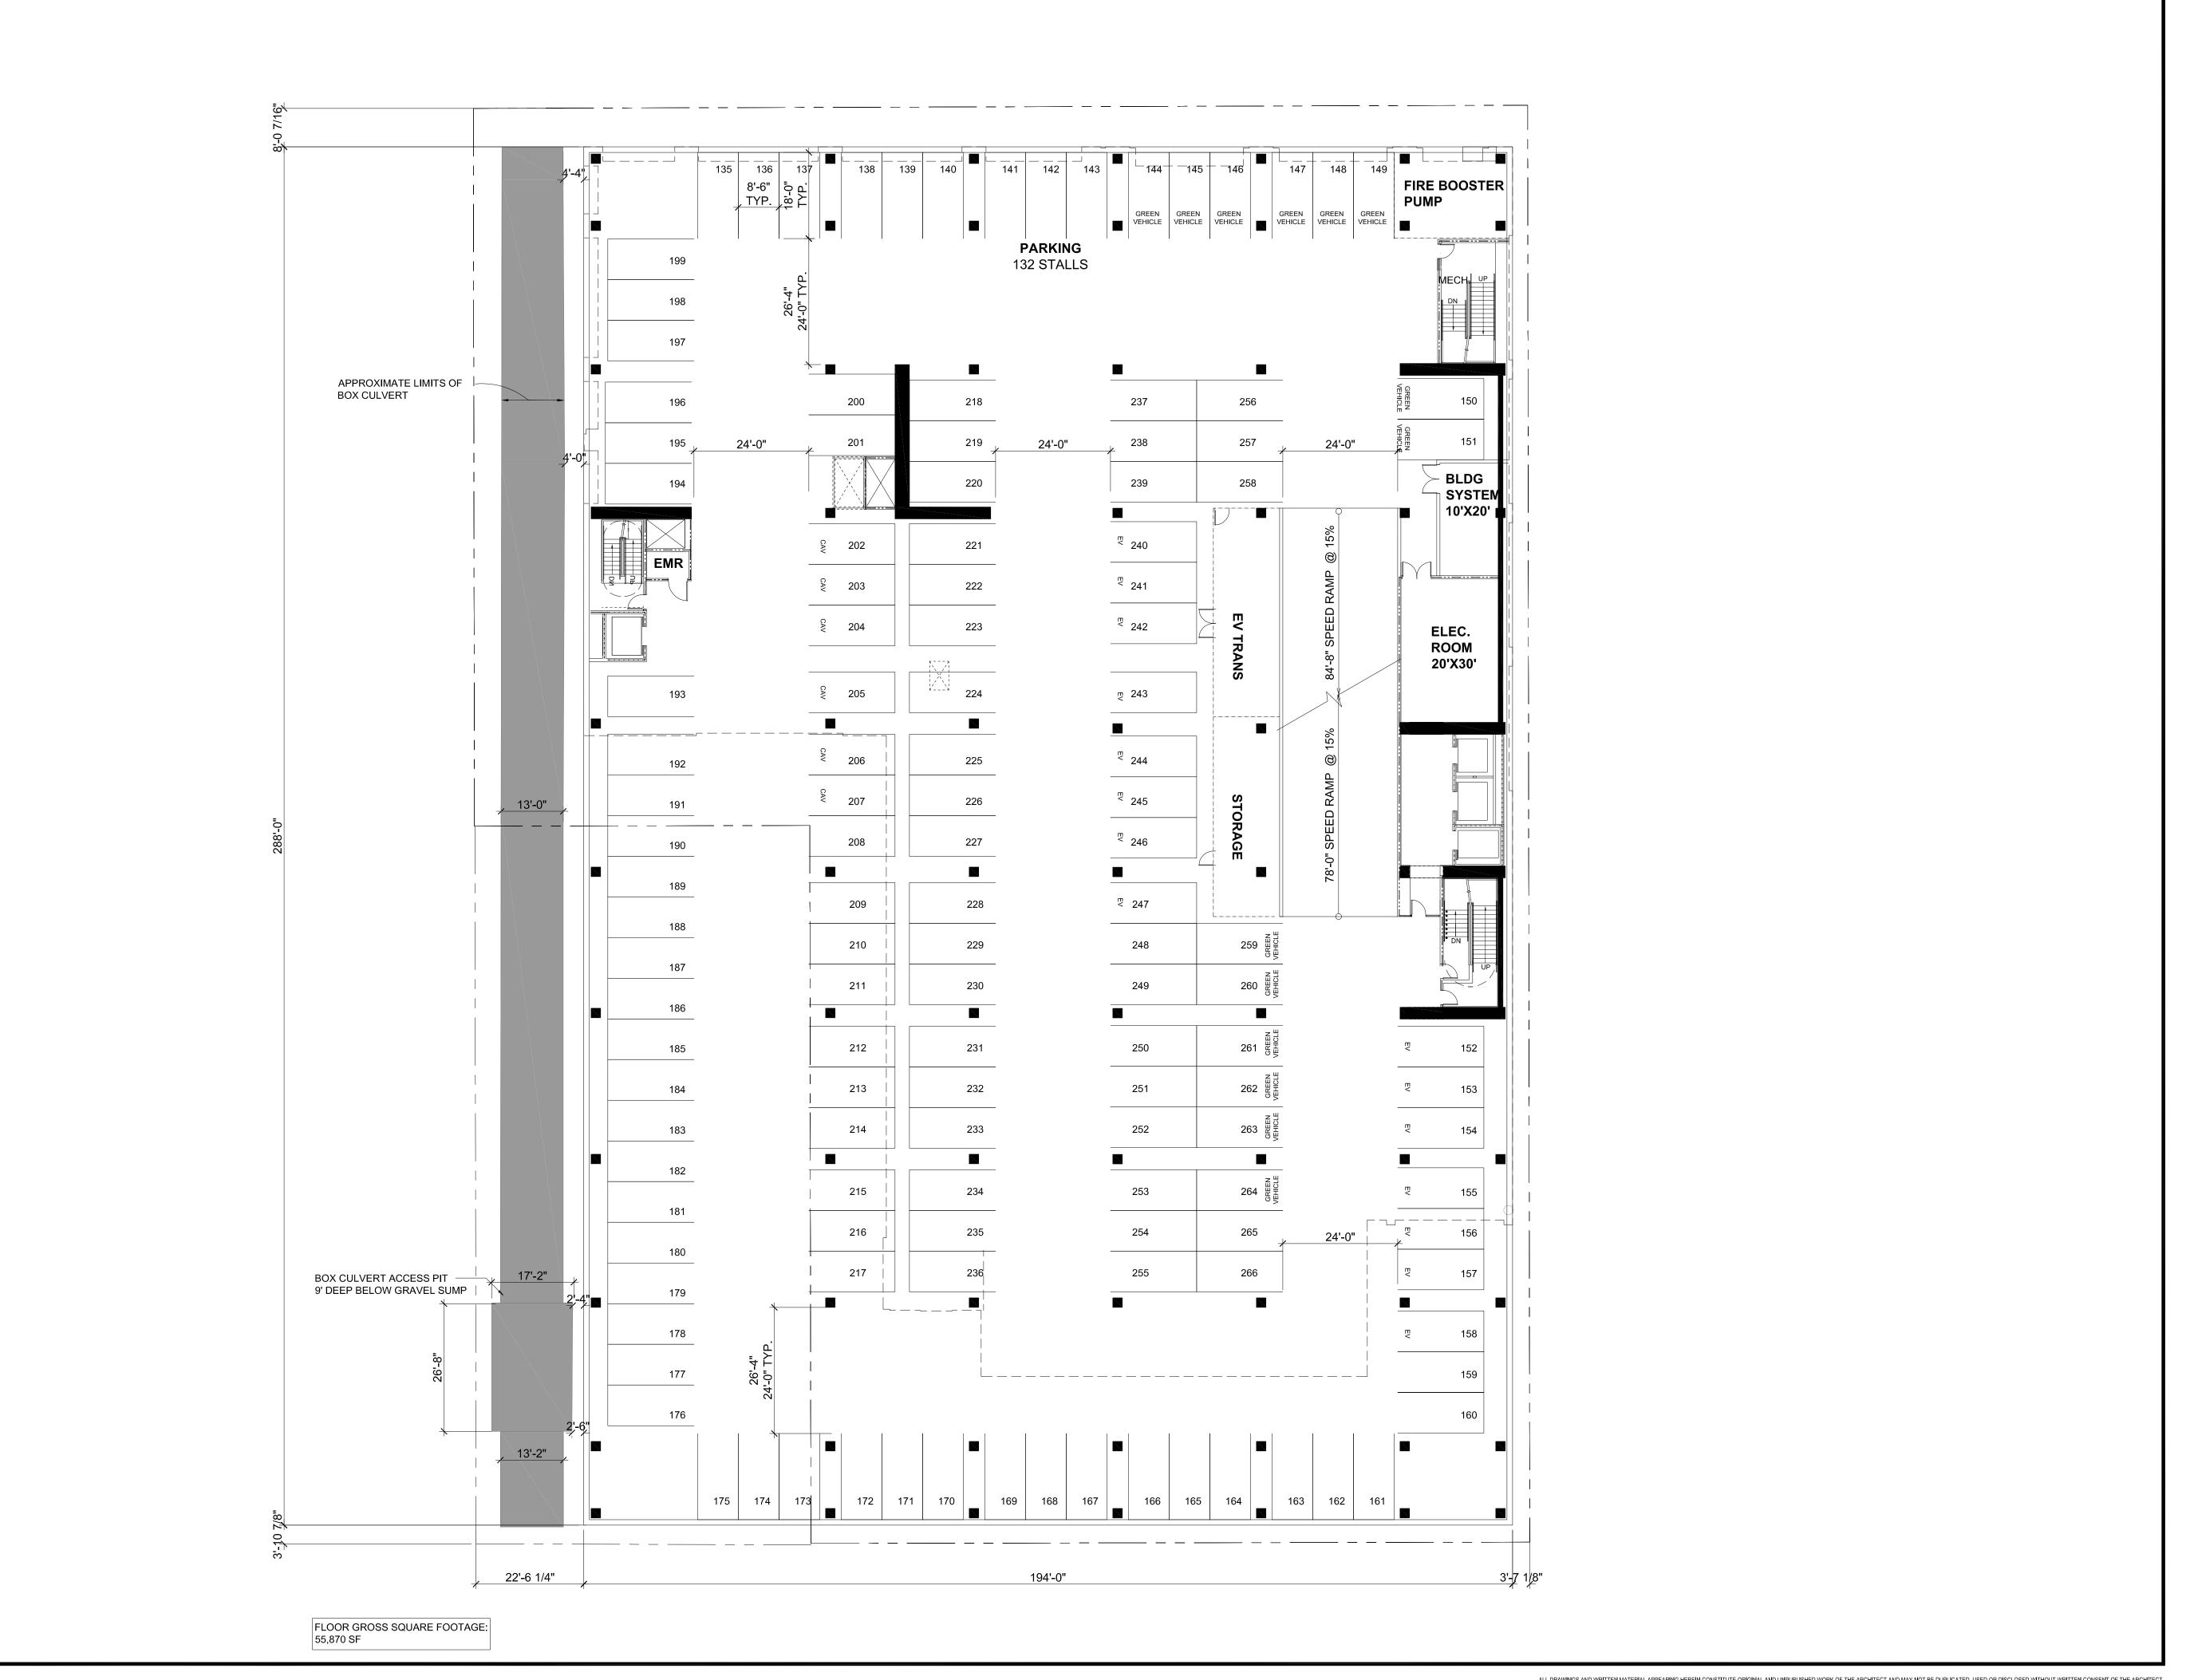

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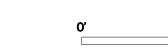
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SHEET TITLE

BELOW GRADE PARKING LEVEL 1

1/16"=1'-0"







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DESCRIPTION

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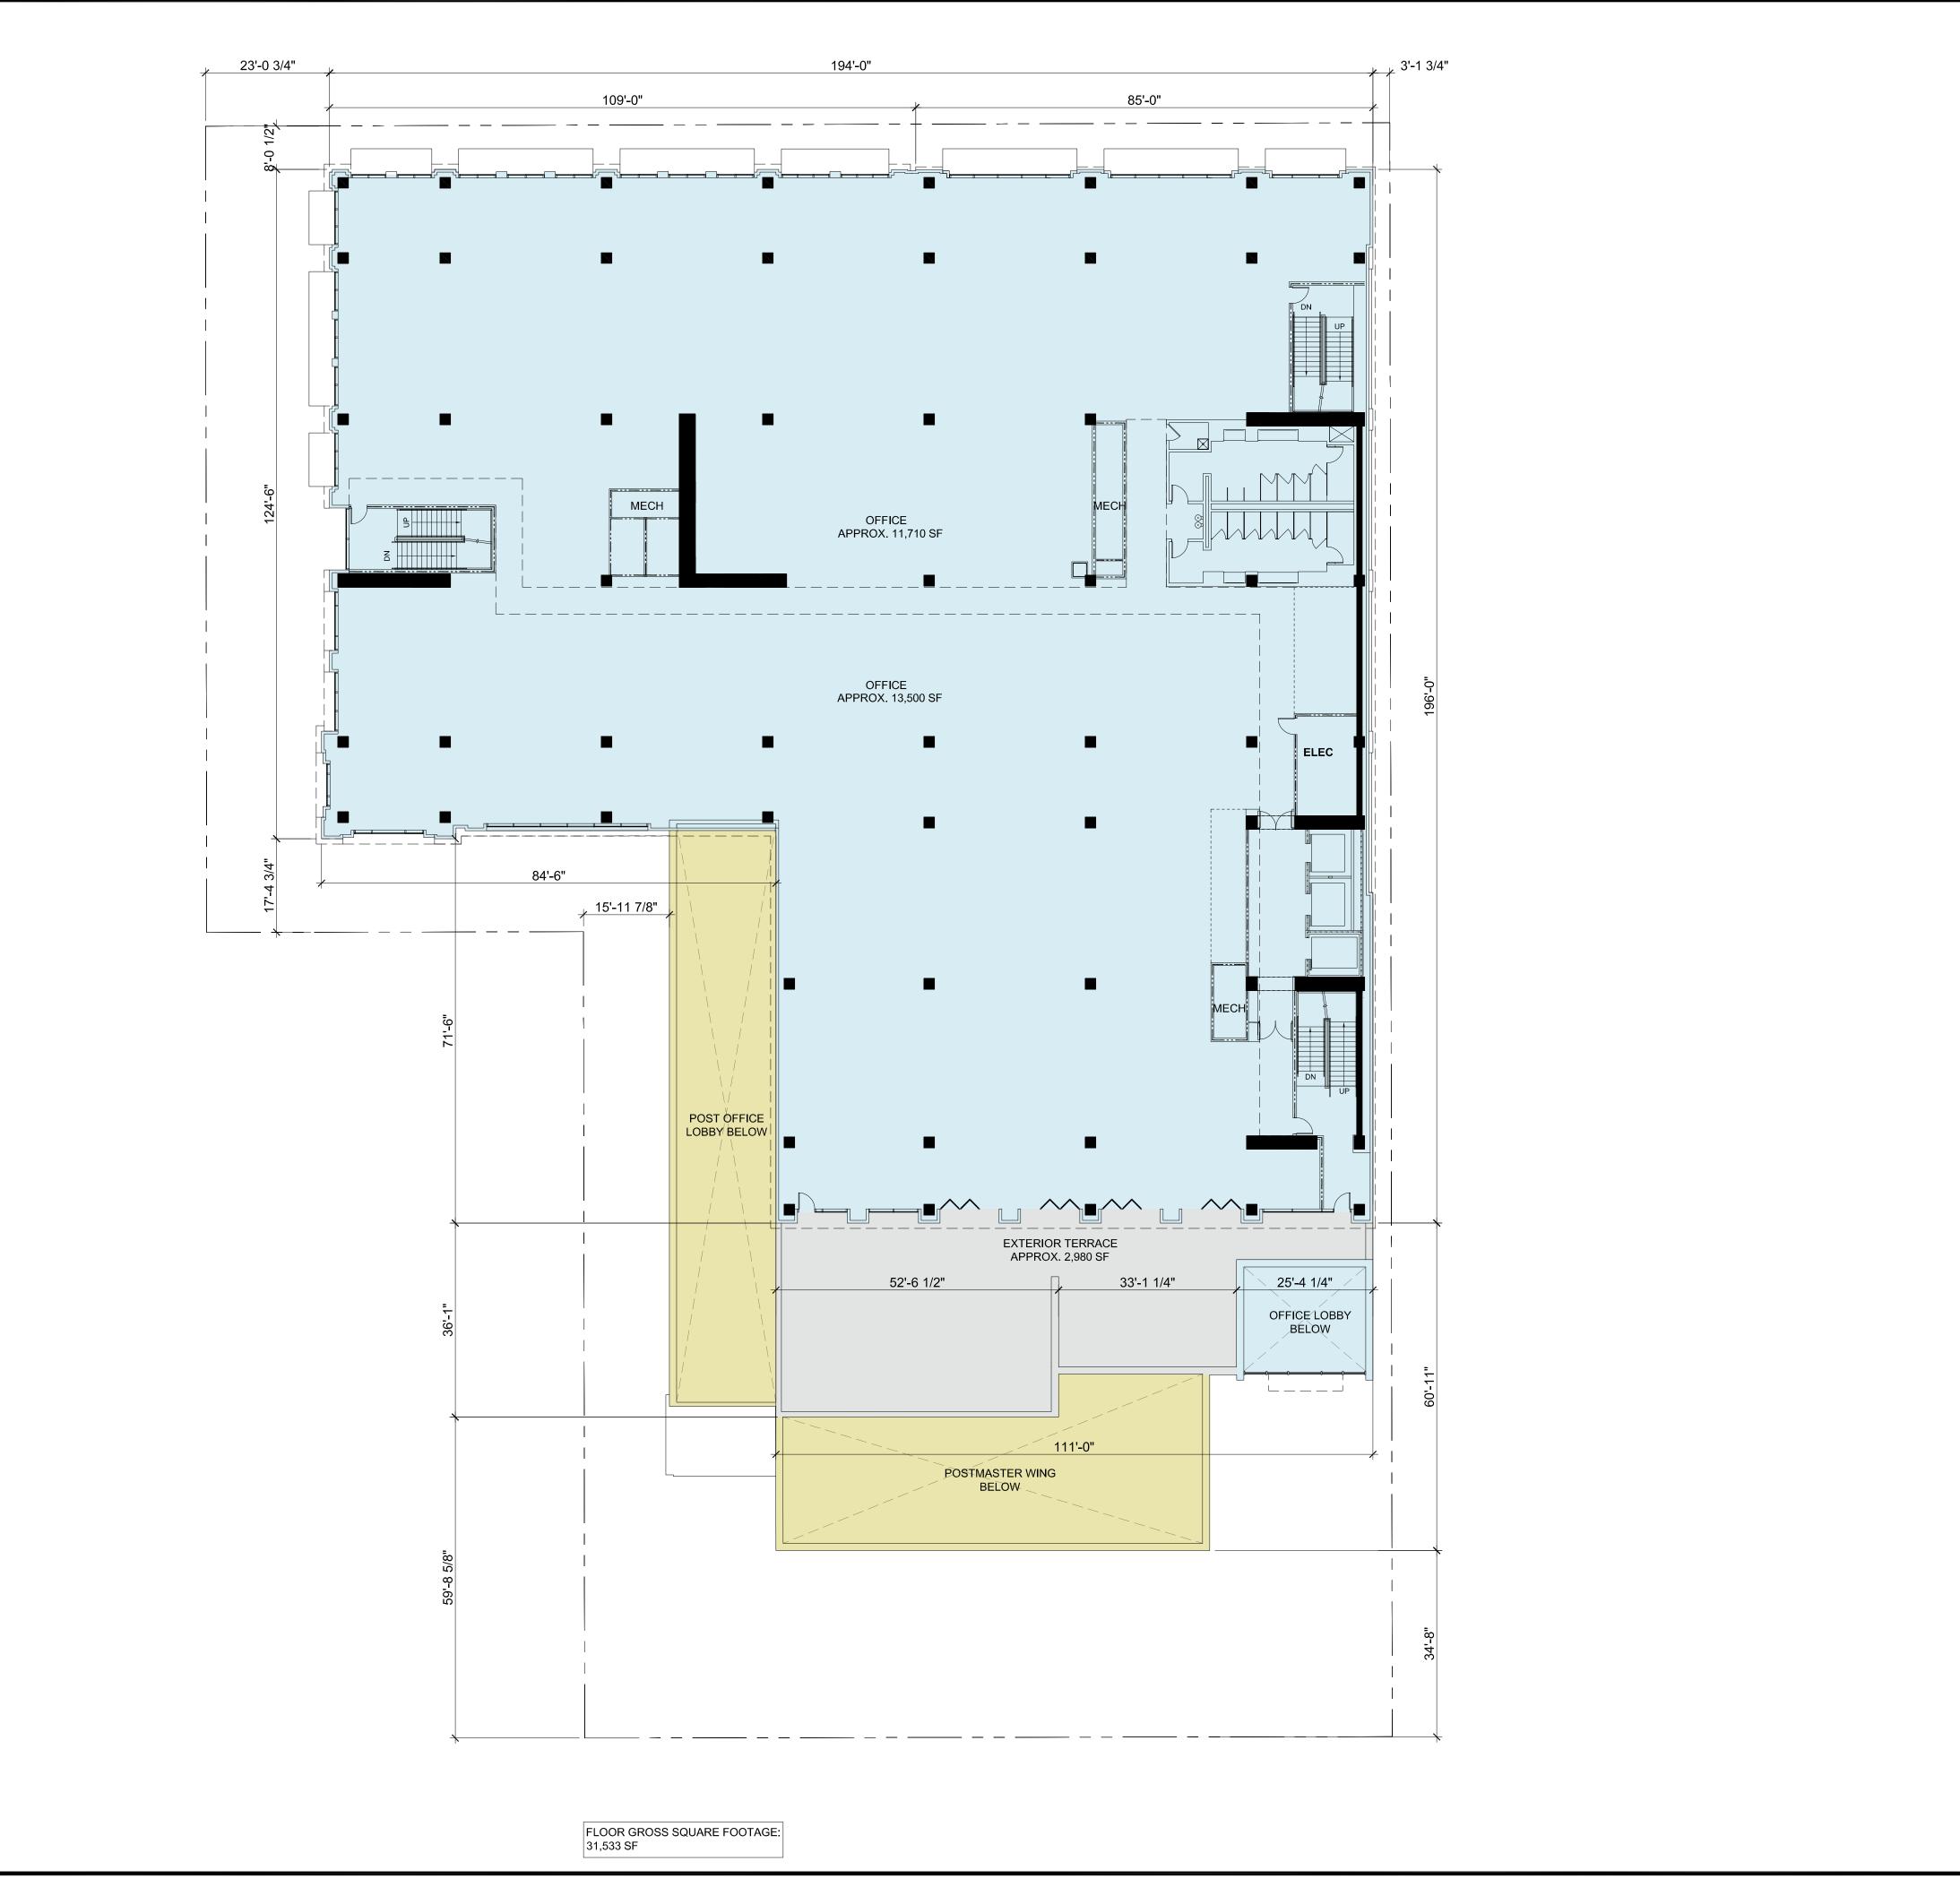
SHEET TITLE

GROUND FLOOR PLAN

SCALE 1/16"=1'-0"









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PROJECT NUM

SHEET TITLE
SECOND FLOOR PLAN

SCALE 1/16"=1'-0"






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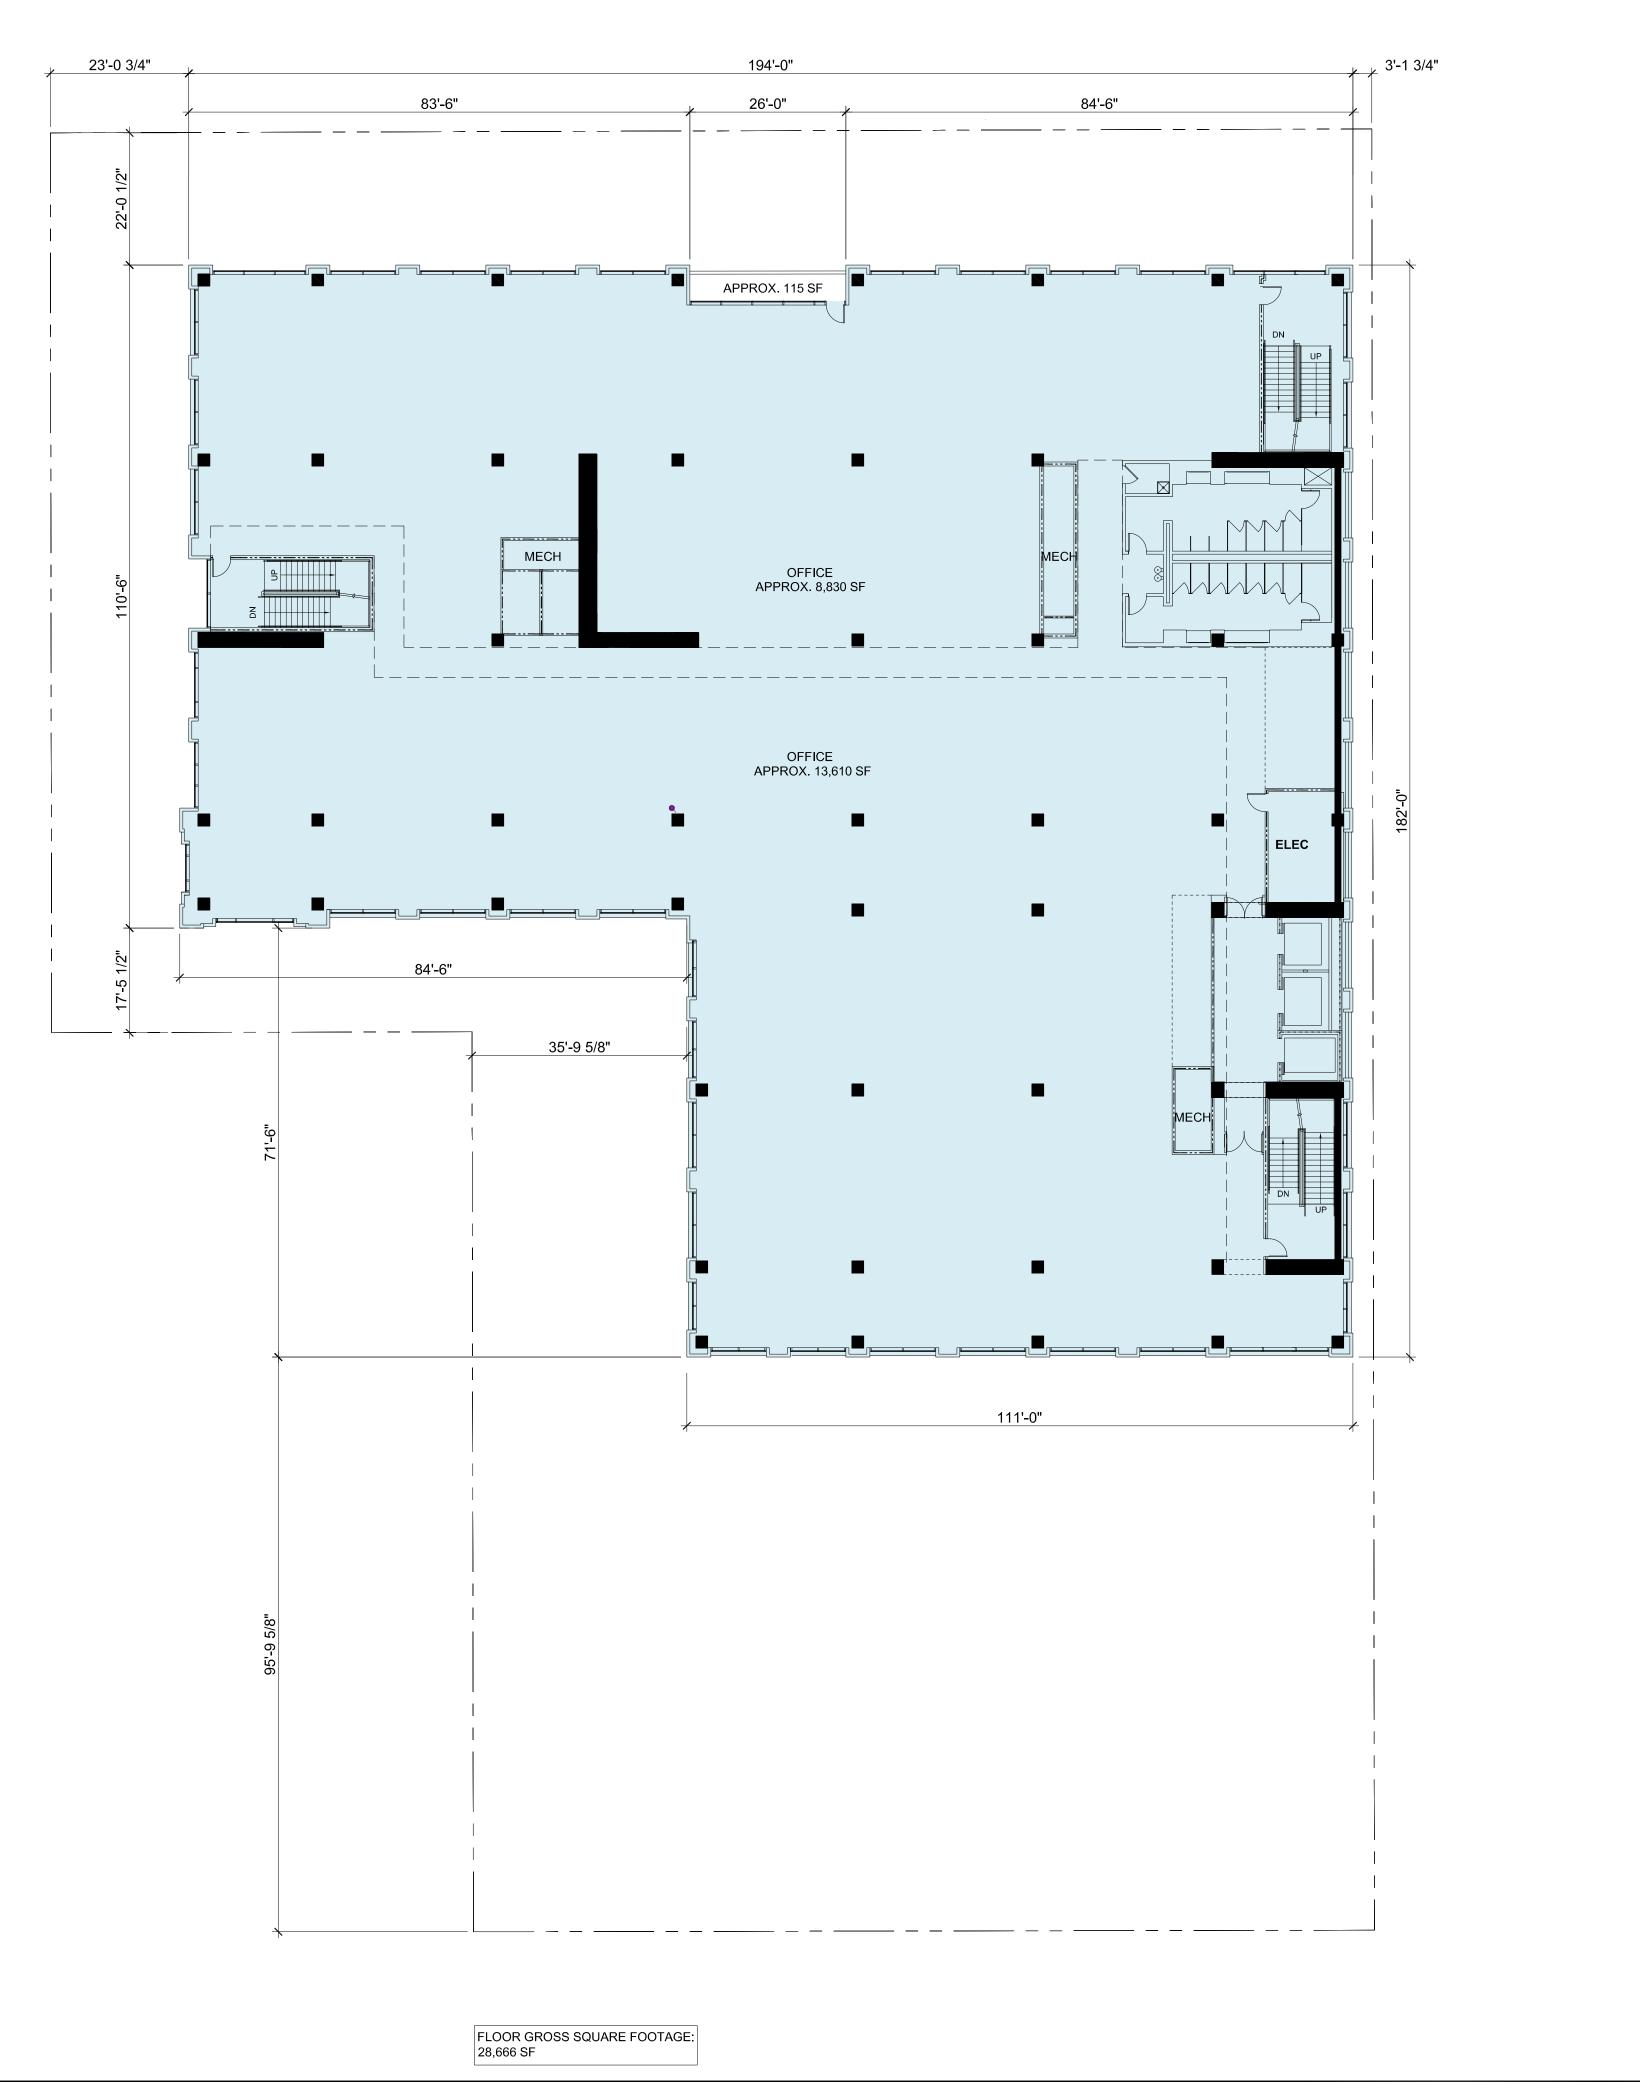
SHEET TITLE
THIRD FLOOR PLAN

SCALE 1/16"=1'-0"



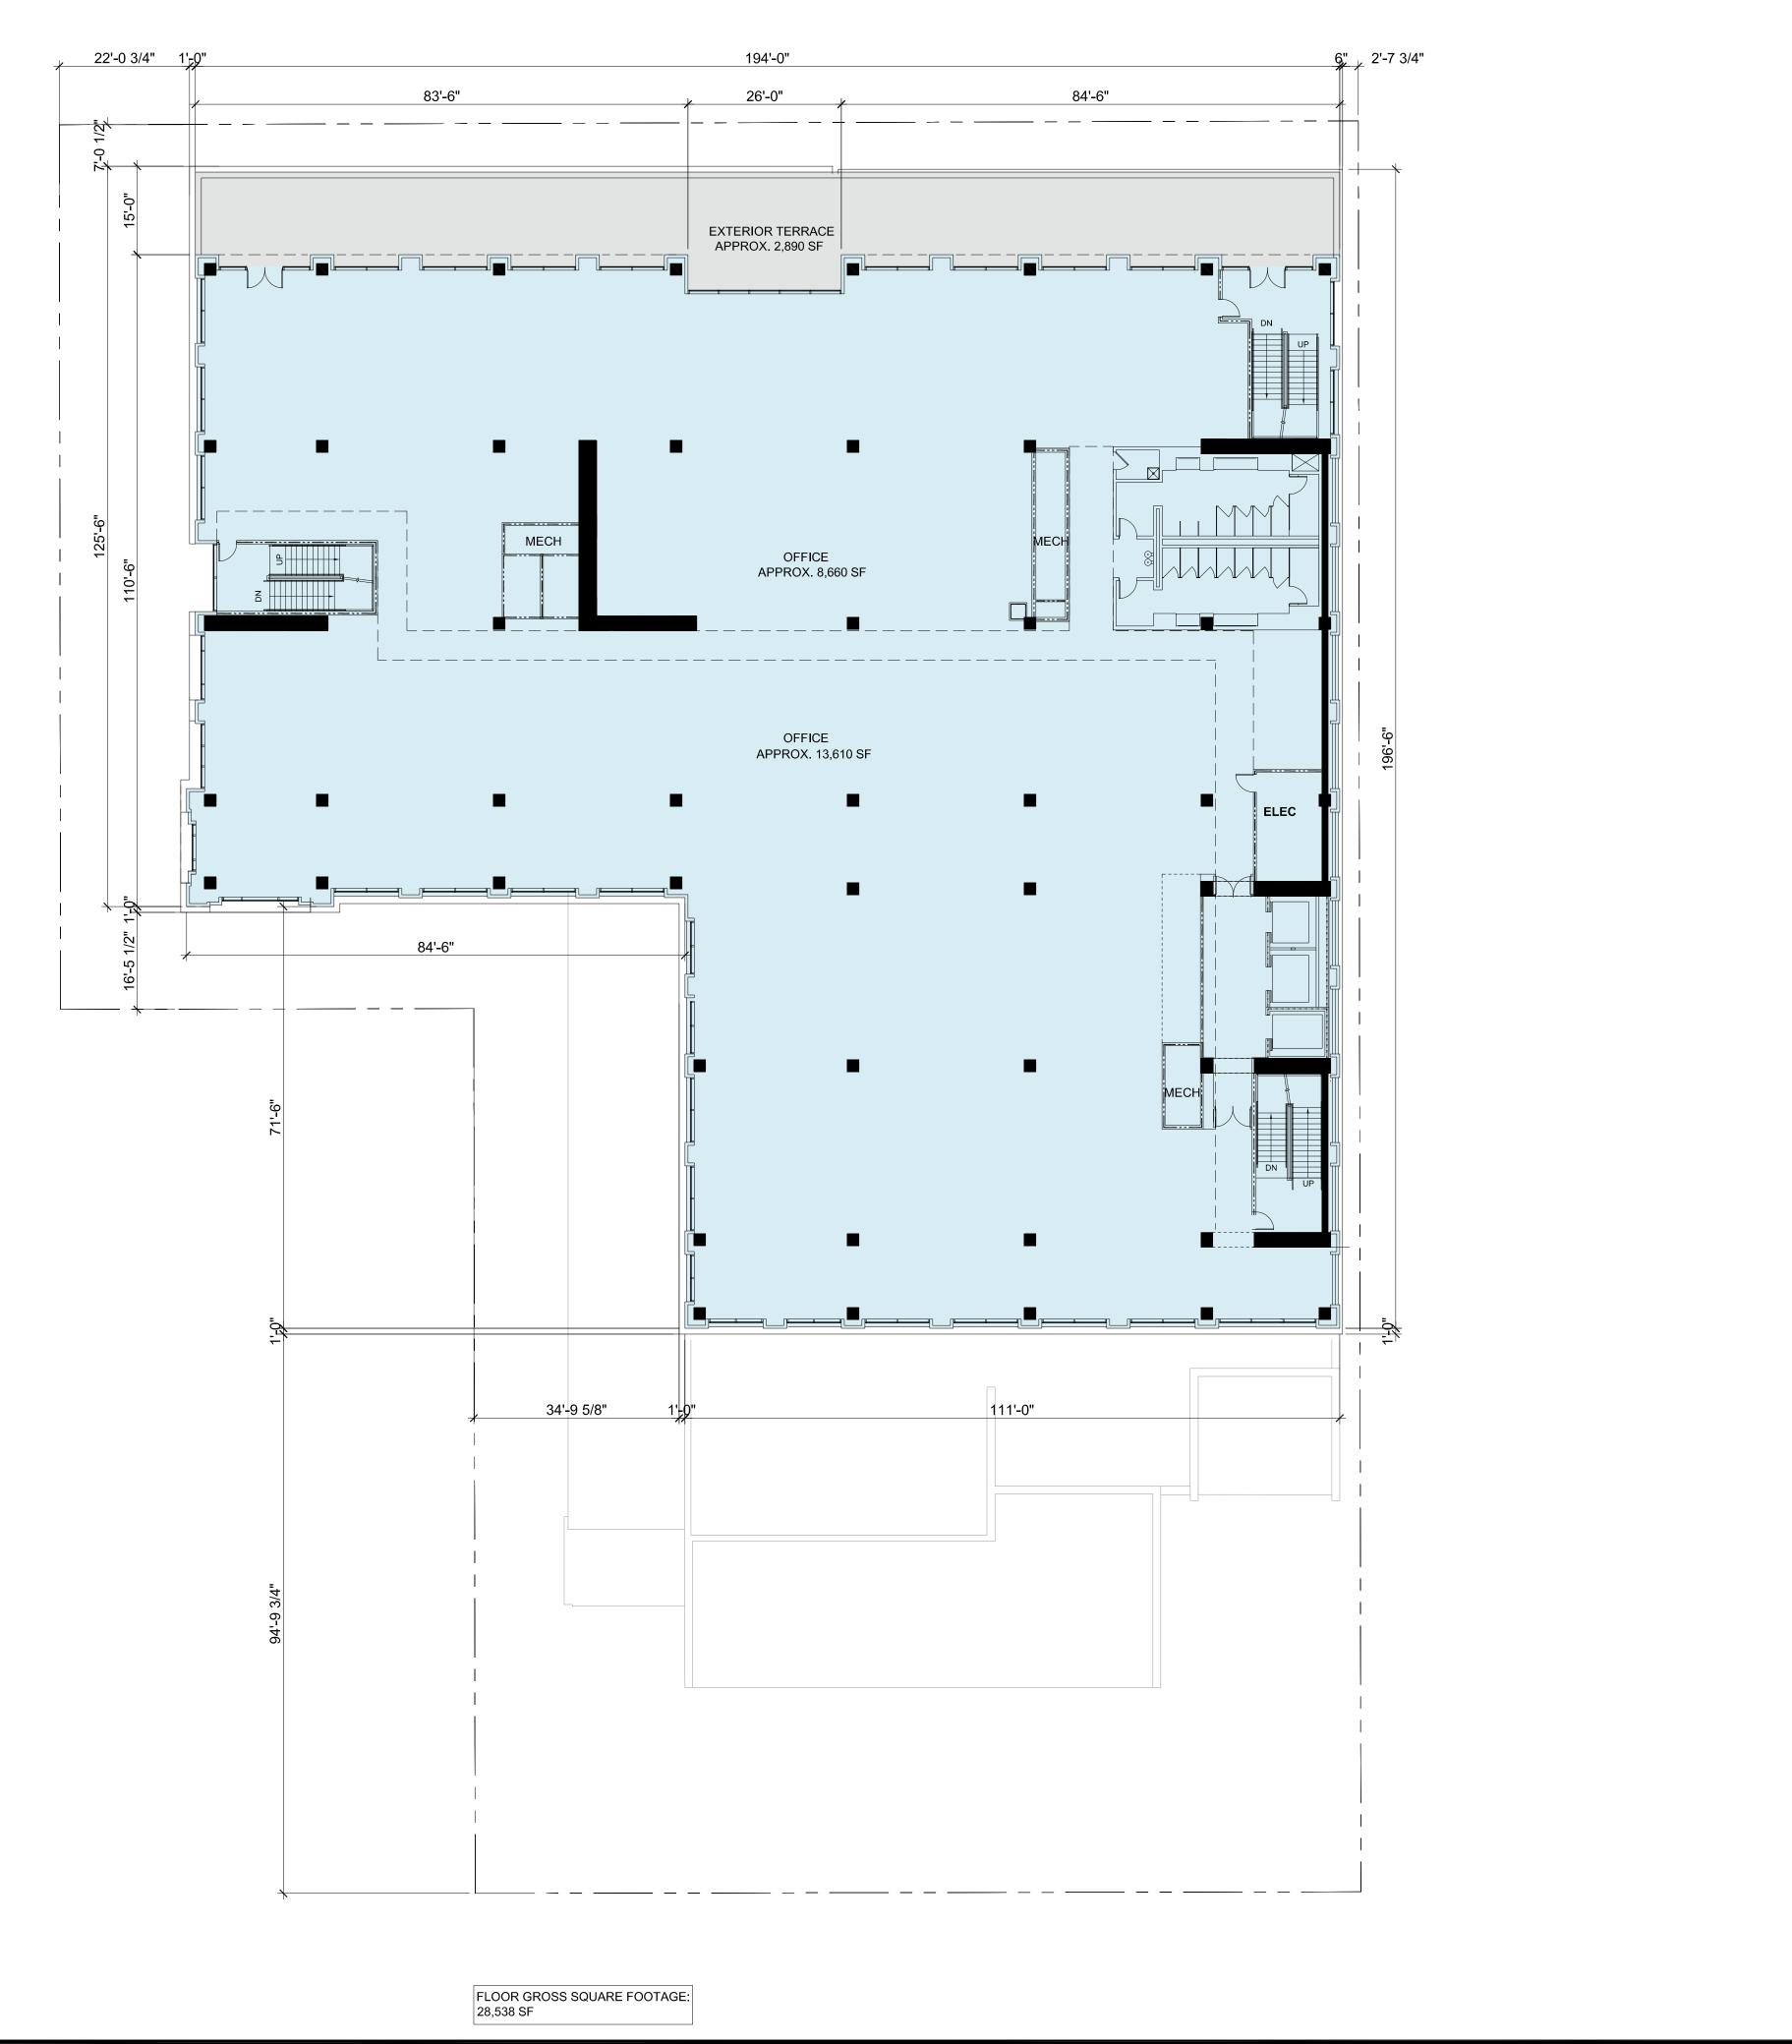





SARES REGIS



220 PARK - BURLINGAME, LLC 220 PARK ROAD BURLINGAME, CA



349 SUTTER STREET SAN FRANCISCO, CA 94108 TEL: 415.954.1960 FAX: 415.954.1970

ISSUES AND REVISIONS

NO. DATE DESCRIPTION

03.30.2020 PLANNING SUBMITTAL


U2U PLANNING RESUBMITTAL #1

PROJECT NUM


SHEET TITLE
FOURTH FLOOR PLAN

SO



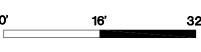



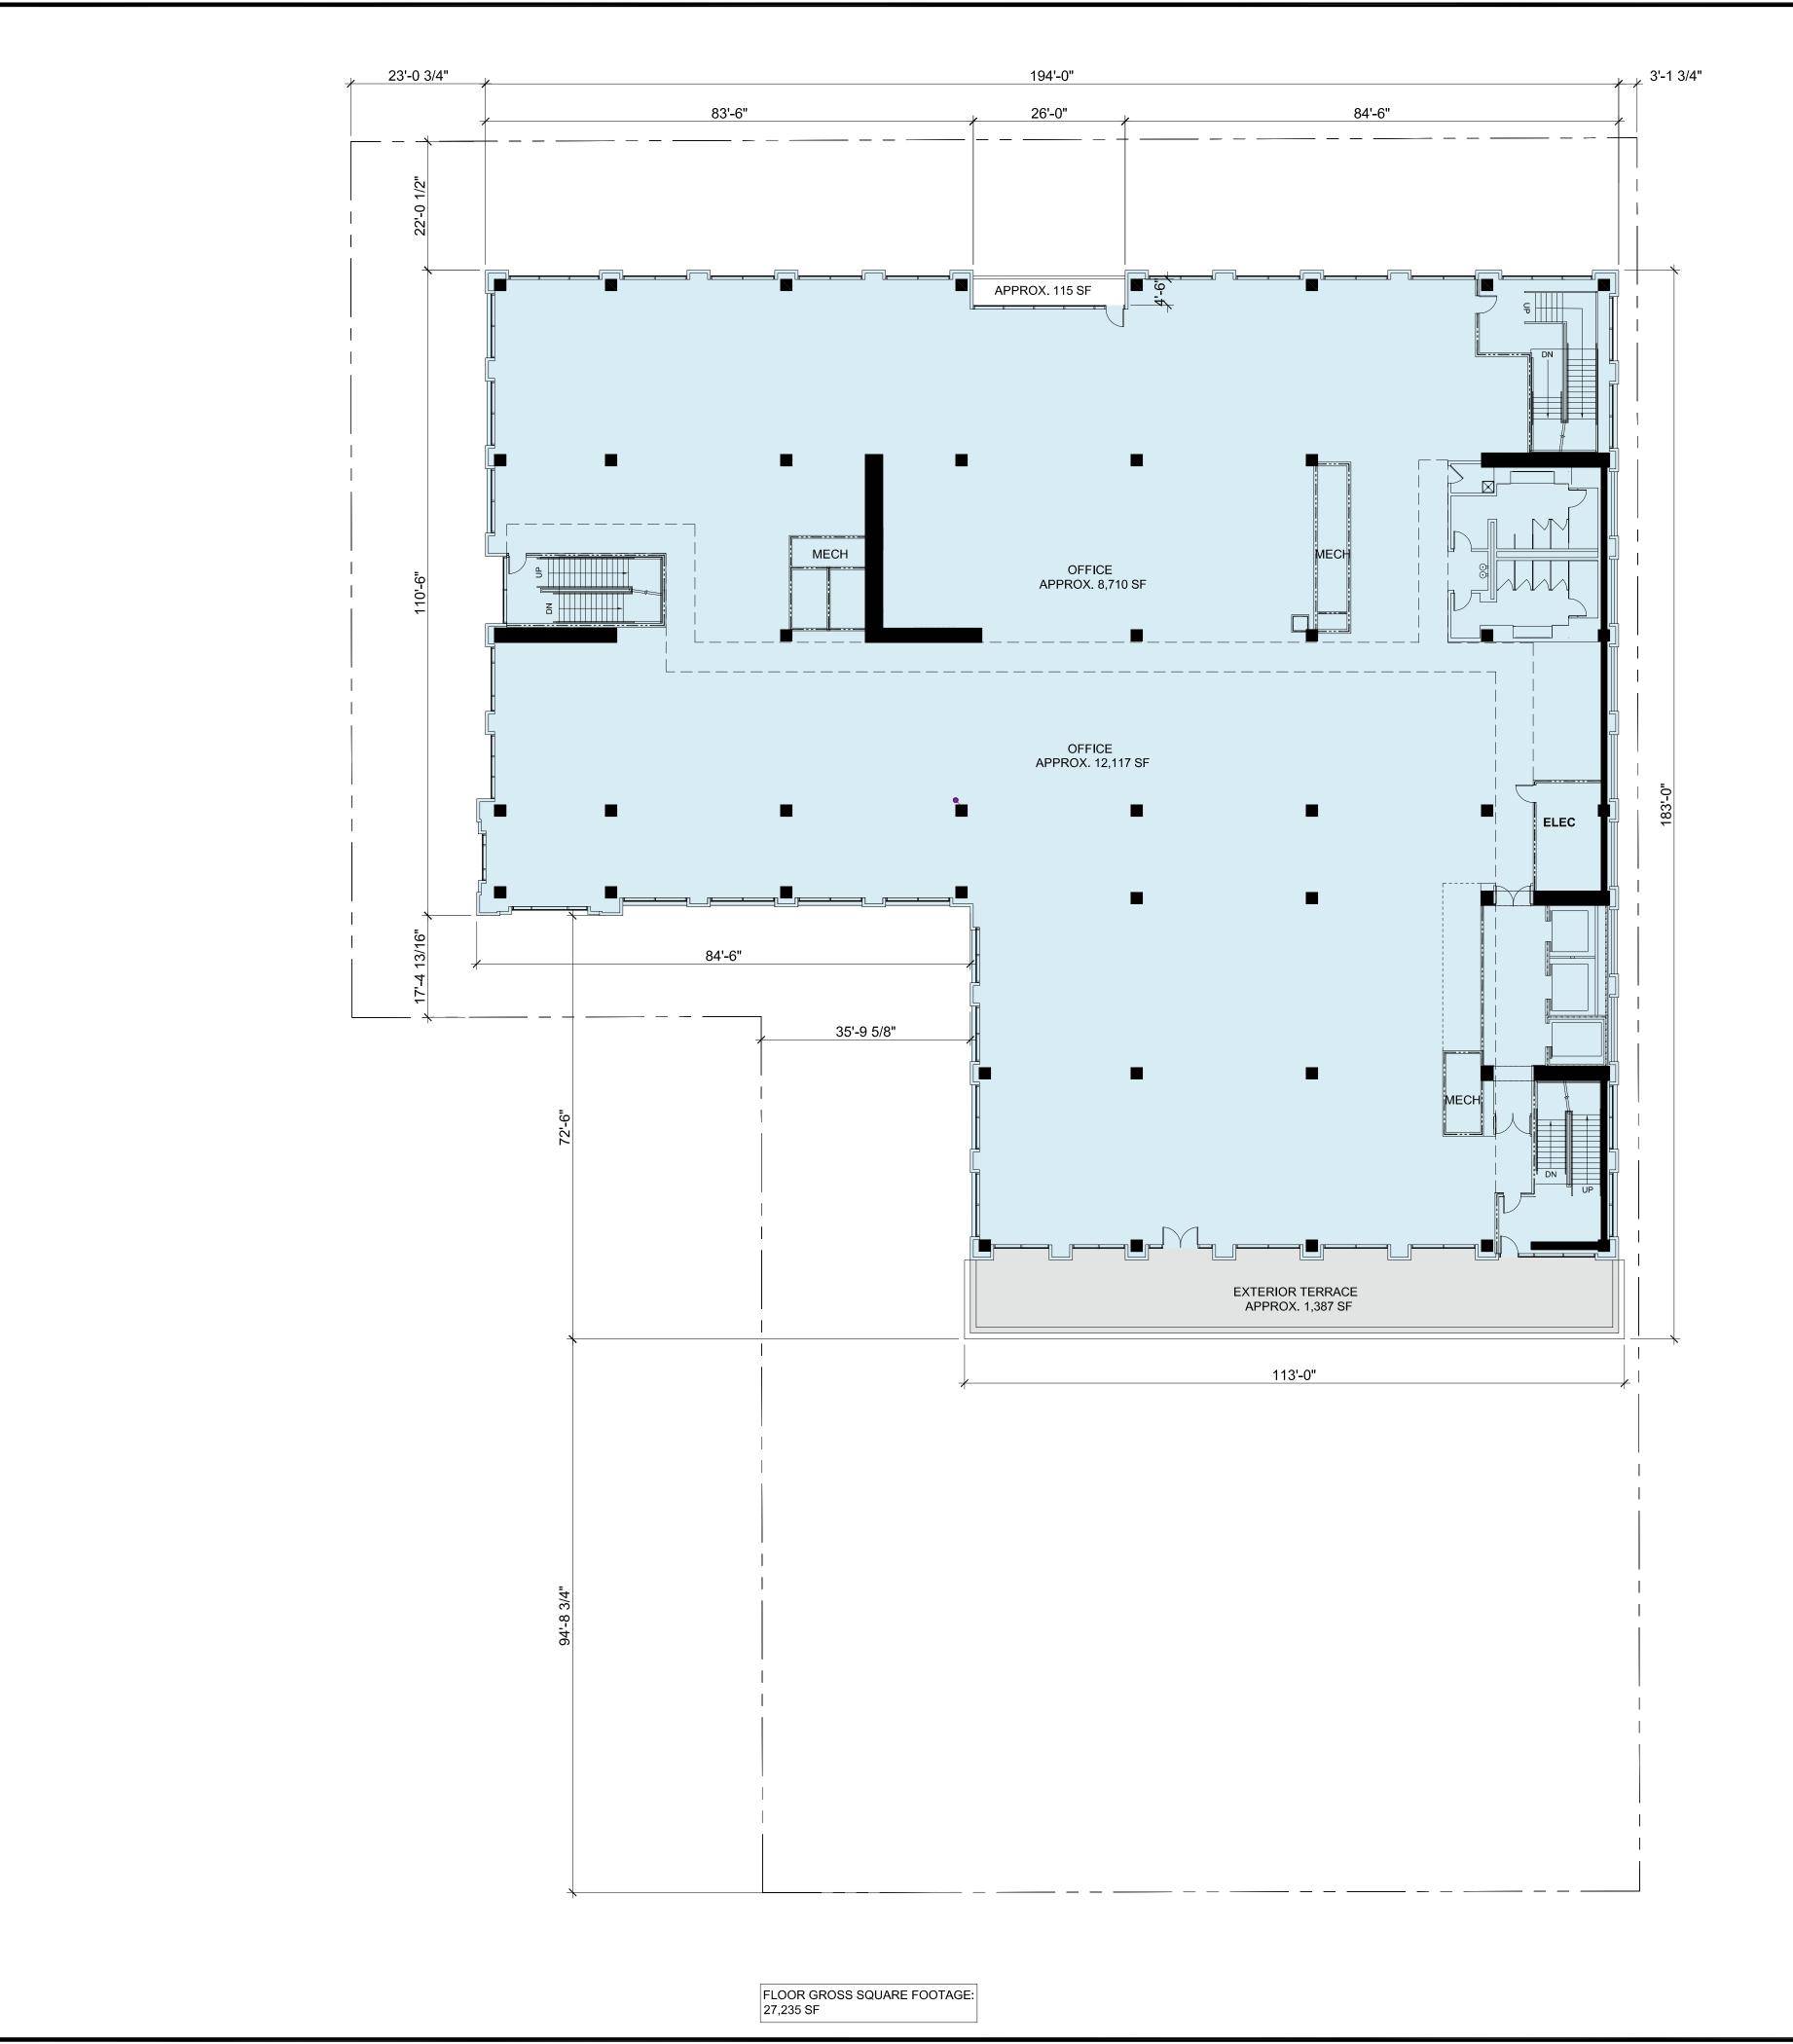

SARES REGIS



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ISSUES AND REVISIONS

DESCRIPTION


03.30.2020 PLANNING SUBMITTAL

(A) 06.22.2020 PLANNING RESUBMITTAL #1

PROJECT NUMBER 19034


FIFTH FLOOR PLAN

1/16"=1'-0"

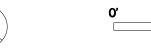





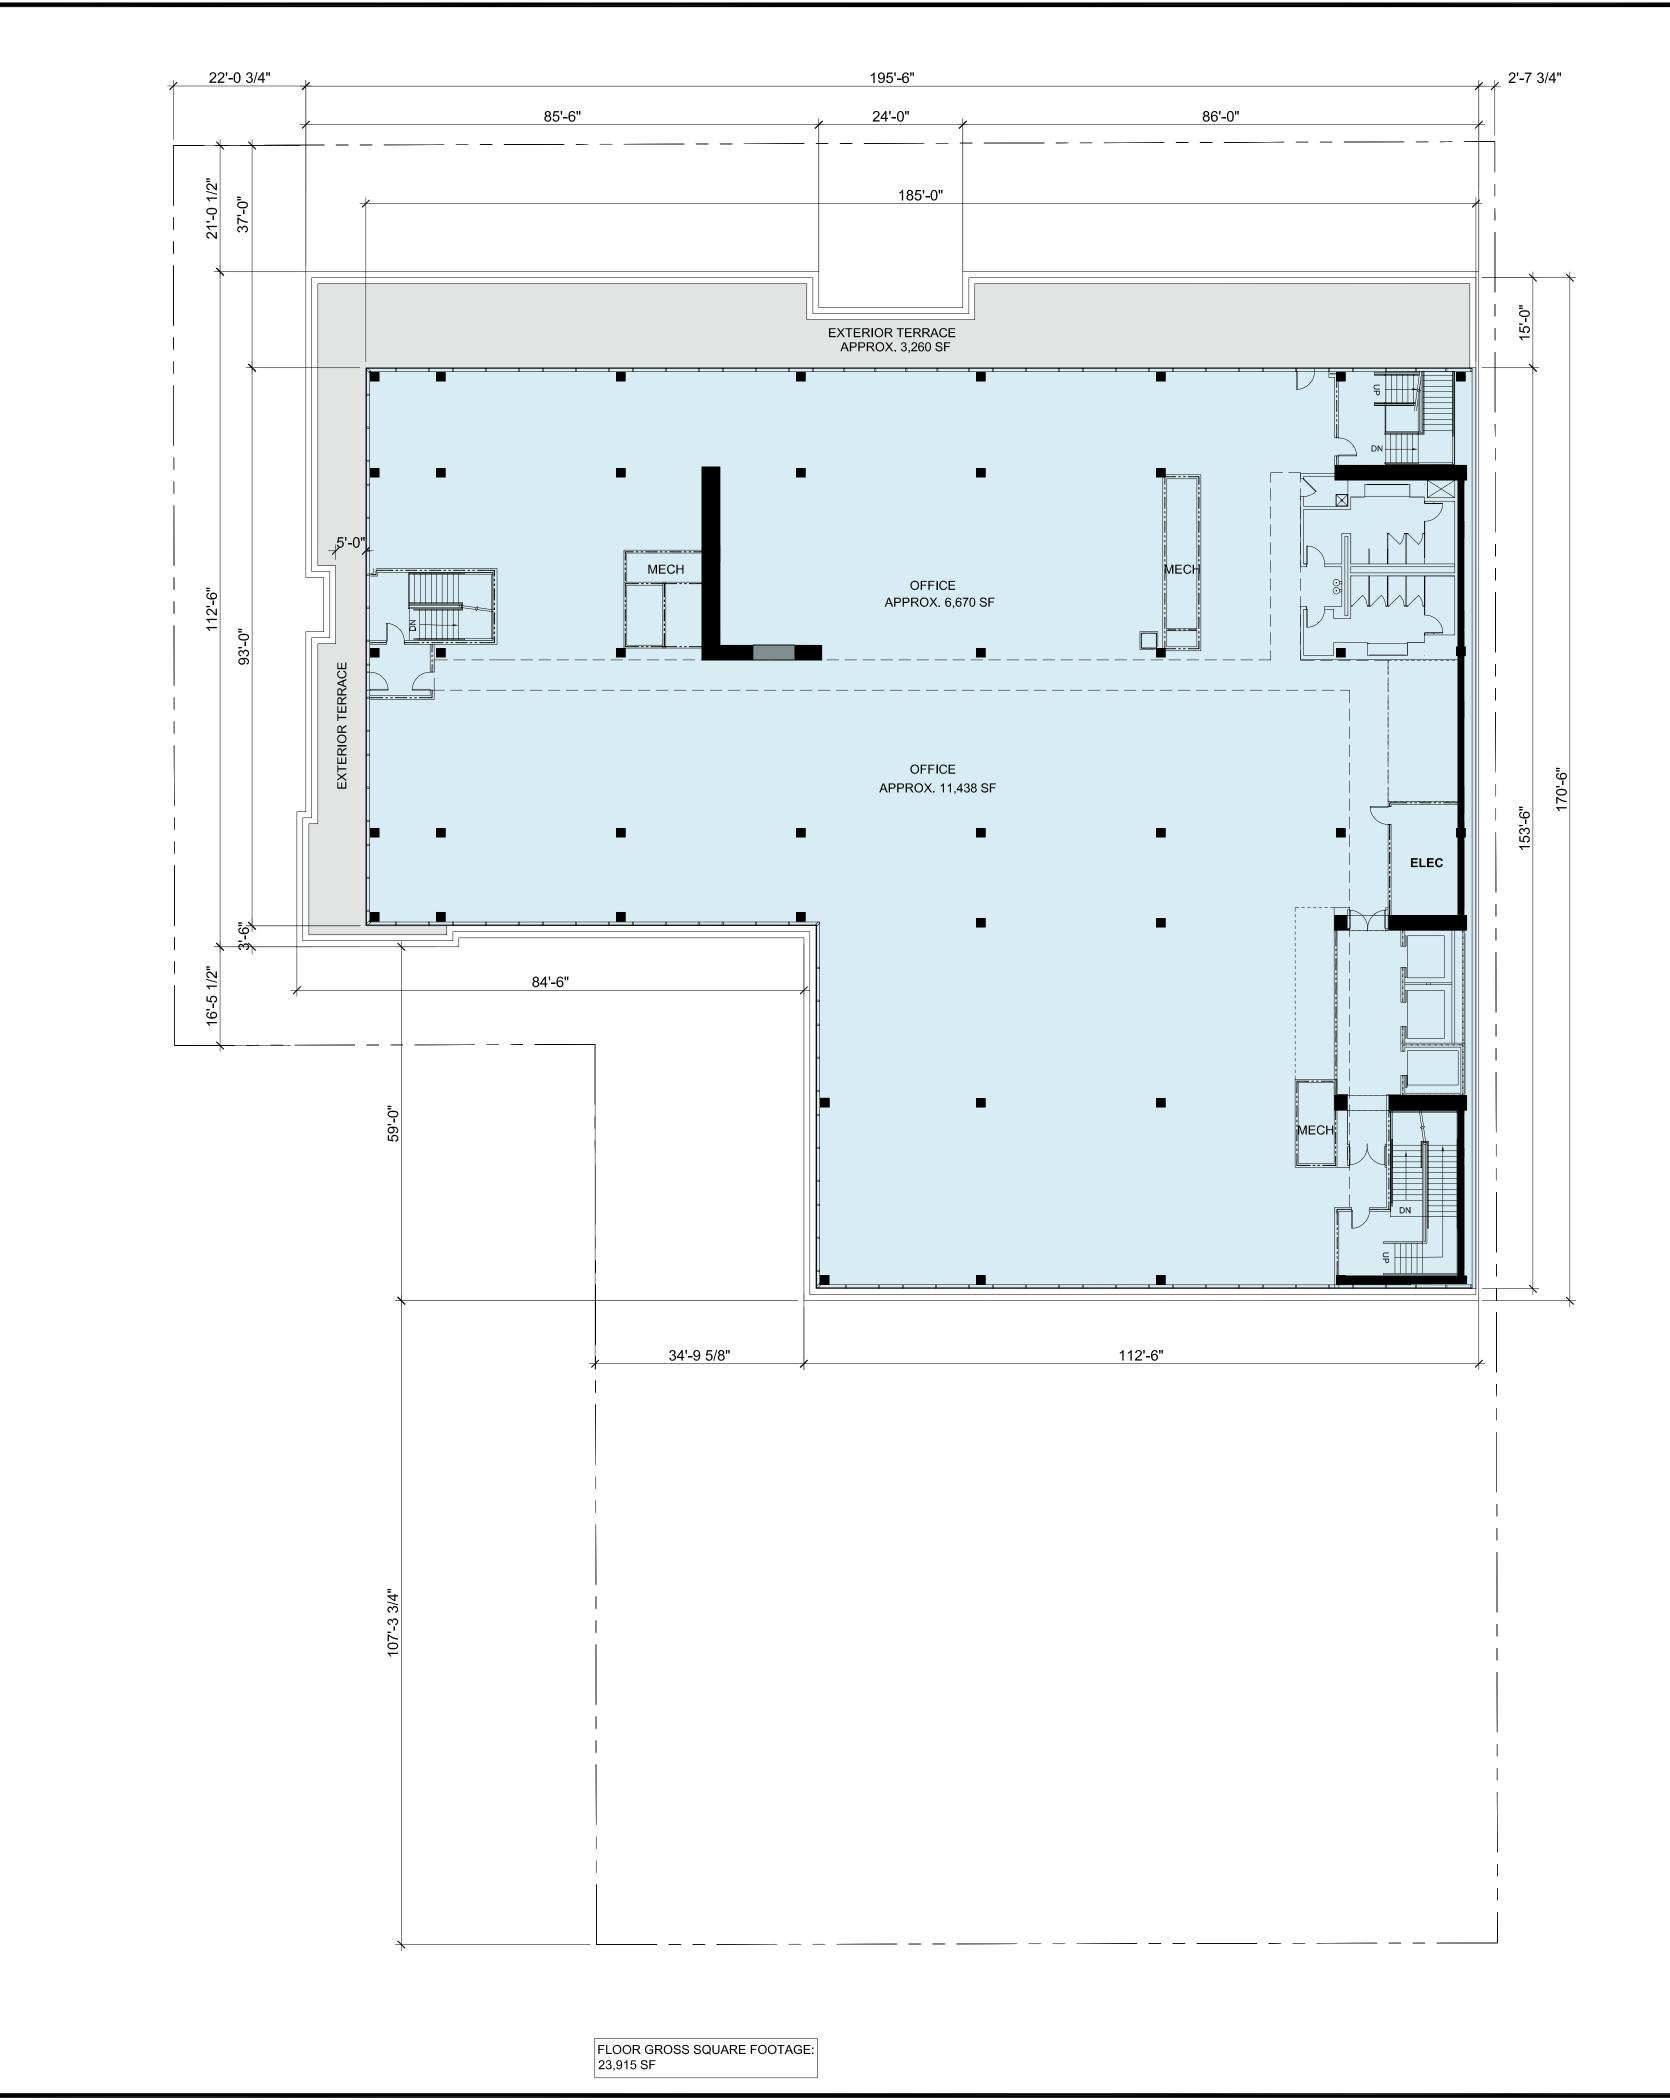

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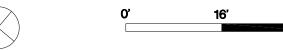
DATE DESCRIPTION

03.30.2020 PLANNING SUBMITTAL


(A) 06.22.2020 PLANNING RESUBMITTAL #1

PROJECT NUME

SIXTH FLOOR PLAN





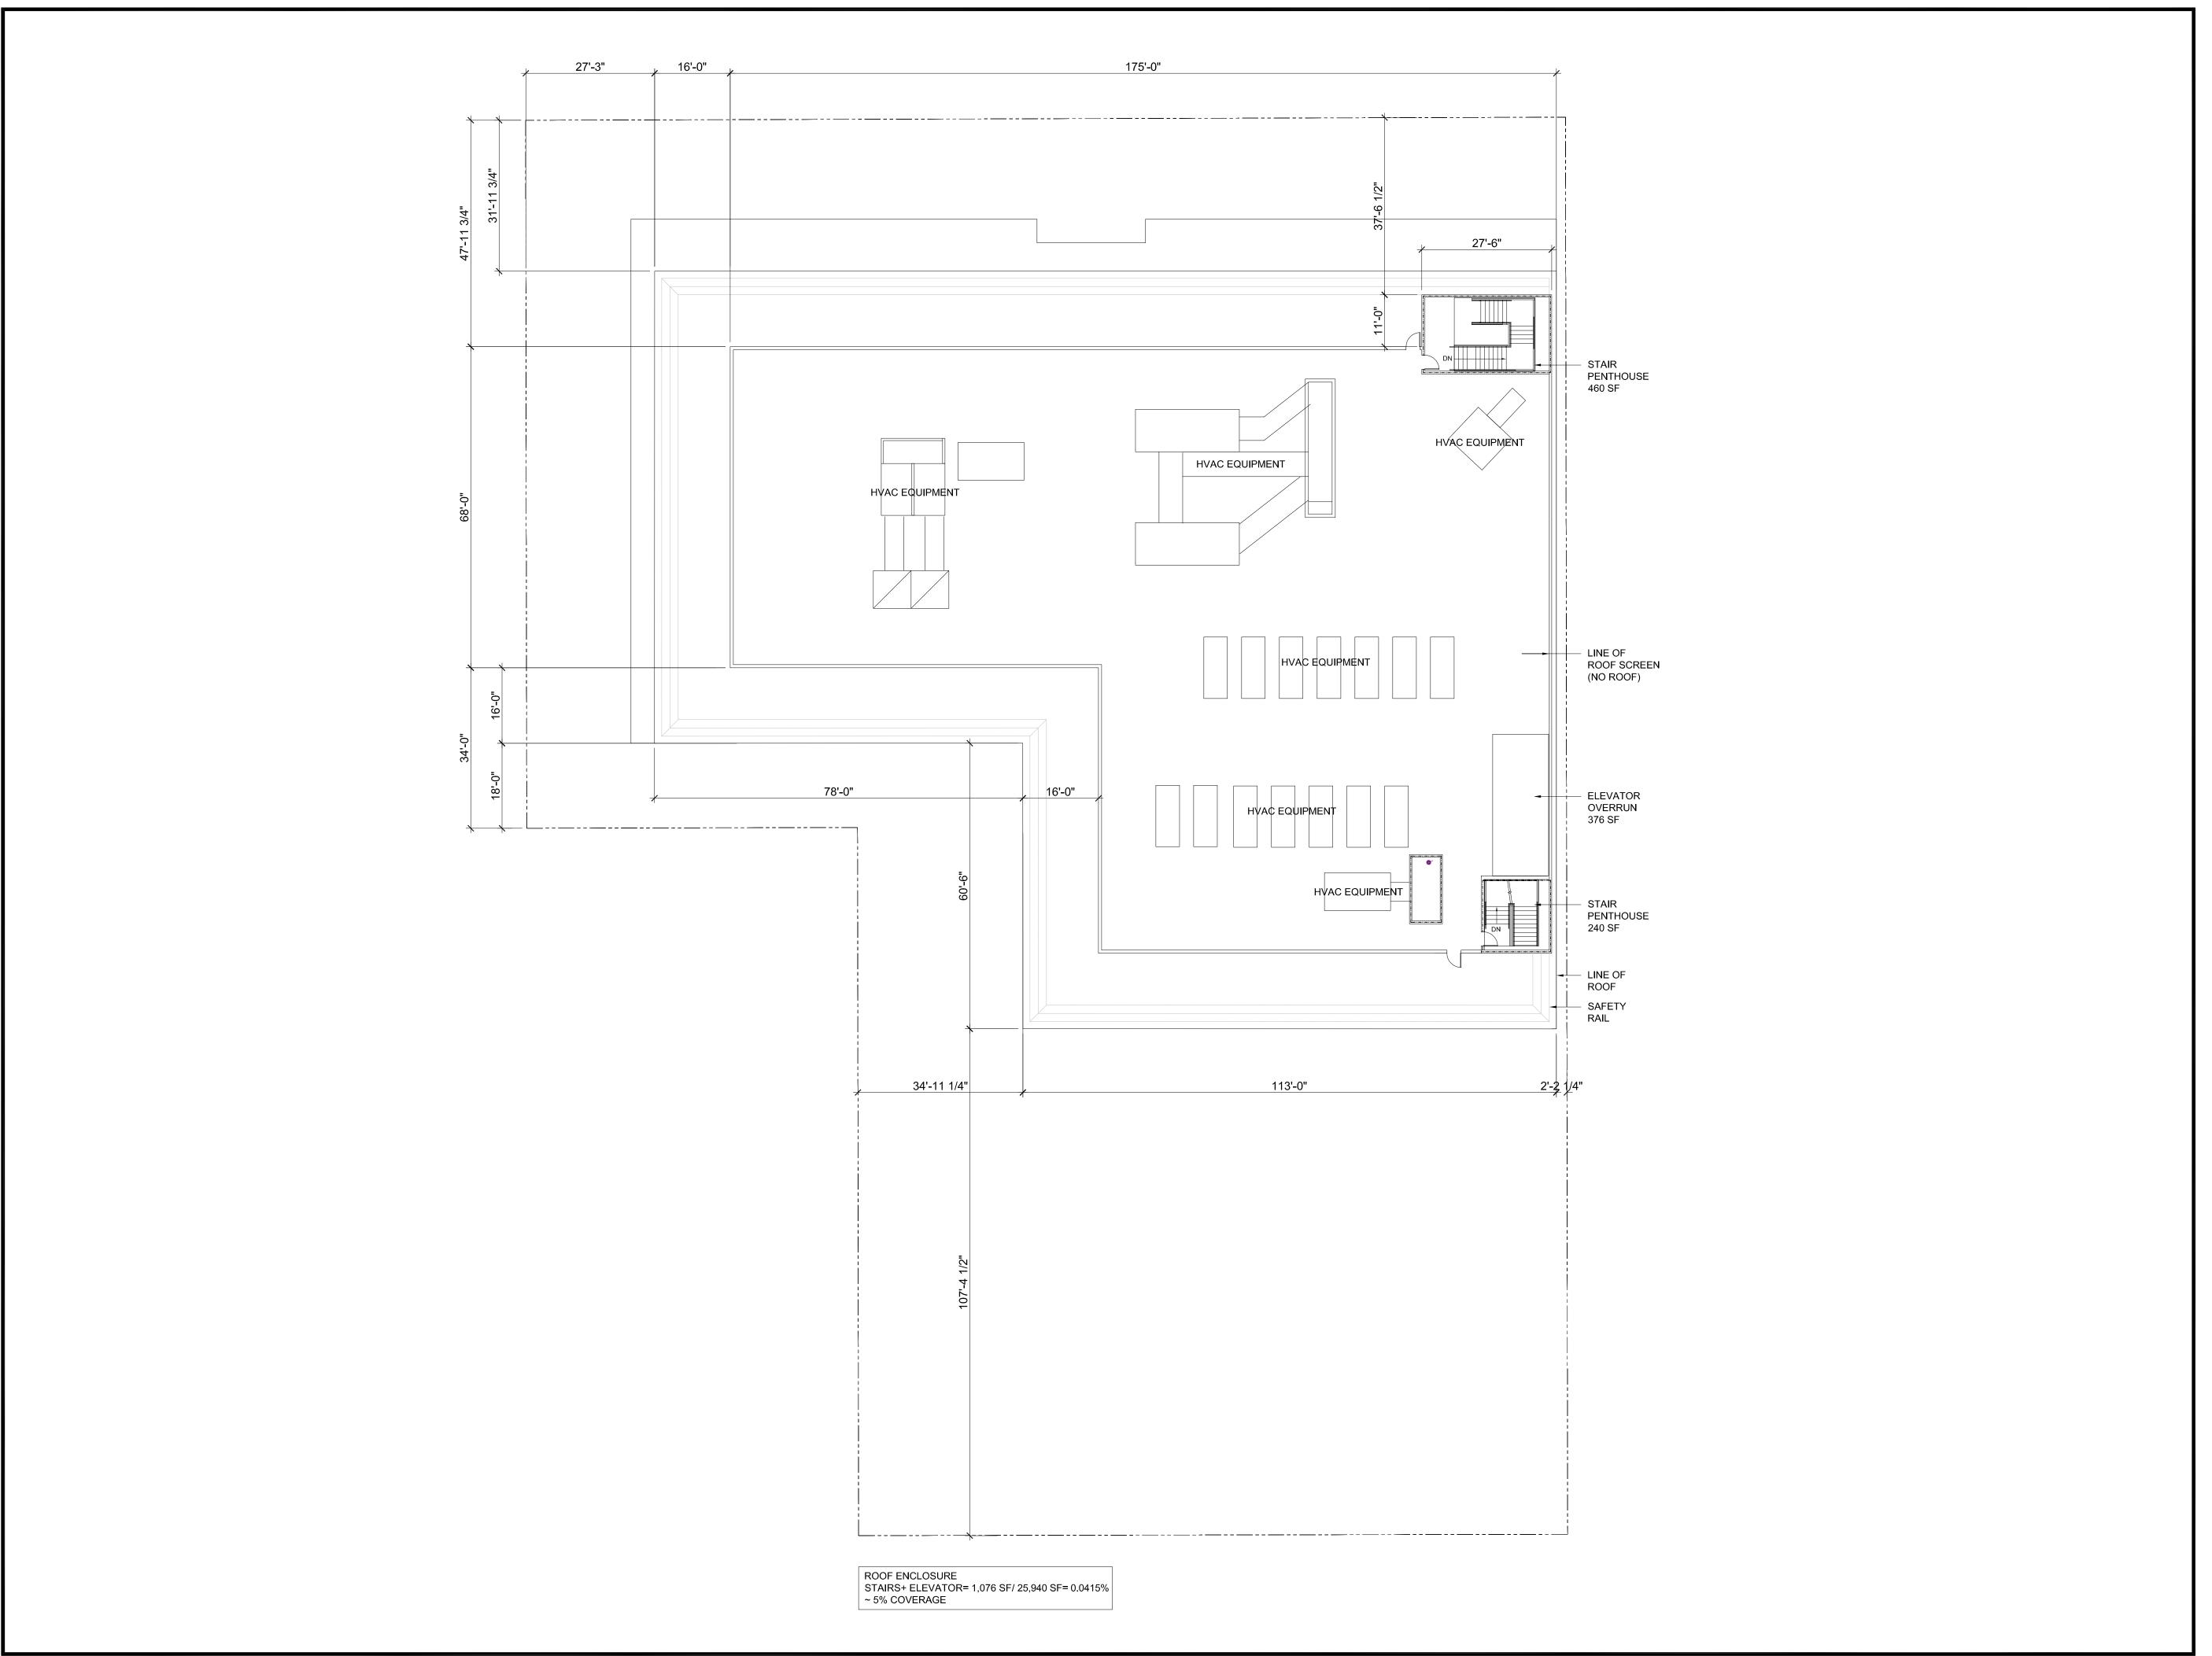

SARES REGIS



220 PARK - BURLINGAME, LLC 220 PARK ROAD BURLINGAME, CA



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NO. DATE DESCRIPTION

03.30.2020 PLANNING SUBMITTAL


A 06.22.2020 PLANNING RESUBMITTAL #1

PROJECT NUMI

SHEET TITLE

ROOF PLAN

SCALE 1/16"=1'-0"

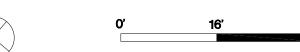





SARES REGIS



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ISSUES AND REVISIONS DESCRIPTION

03.30.2020 PLANNING SUBMITTAL (A) 06.22.2020 PLANNING RESUBMITTAL #1

PROJECT NUMBER 19034

SHEET TITLE **EXISTING ELEVATIONS**

1/16"=1'-0"







SARES REGIS



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ISSUES AND REVISIONS

NO. DATE DESCRIPTION

03.30.2020 PLANNING SUBMITTAL


06.22.2020 PLANNING RESUBMITTAL #1

PROJECT NUMBER 19034

SHEET TITLE
ELEVATIONS

SCALE

1/16"=1'-0"

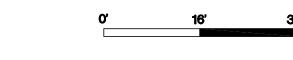







NORTHWEST ELEVATION

220 PARK ROAD

SARES REGIS



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ISSUES AND REVISIONS

DATE DESCRIPTION

03.30.2020 PLANNING SUBMITTAL

△ 06.22.2020 PLANNING RESUBMITTAL #1

PROJECT NUMBER 19034


SHEET TITLE
ELEVATIONS

SCALE 1/16"=1'-0"





SHEET NUMBER

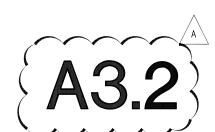

CLEAR VISION GLASS, TYP.

